construction plans for:

## McGREGOR PARK

## CITY OF CAPITOLA McGREGOR DRIVE, CAPITOLA April 16, 2014

## Sheet Index

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Cover shee	hee

1 Survey

L - 1.0 West Grading + Drainage, Erosion Control, Tree Protection Plan

L - 1.1 East Grading + Drainage, Erosion Control, Tree Protection Plan

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L - 2.0 West Layout + Materials Plan

L - 2.1 East Layout + Materials Plan

L - 2.2 Layout + Materials Details

L - 2.3 Site furnishings and Lighting Cut Sheets

L - 3.0 West Planting Plan

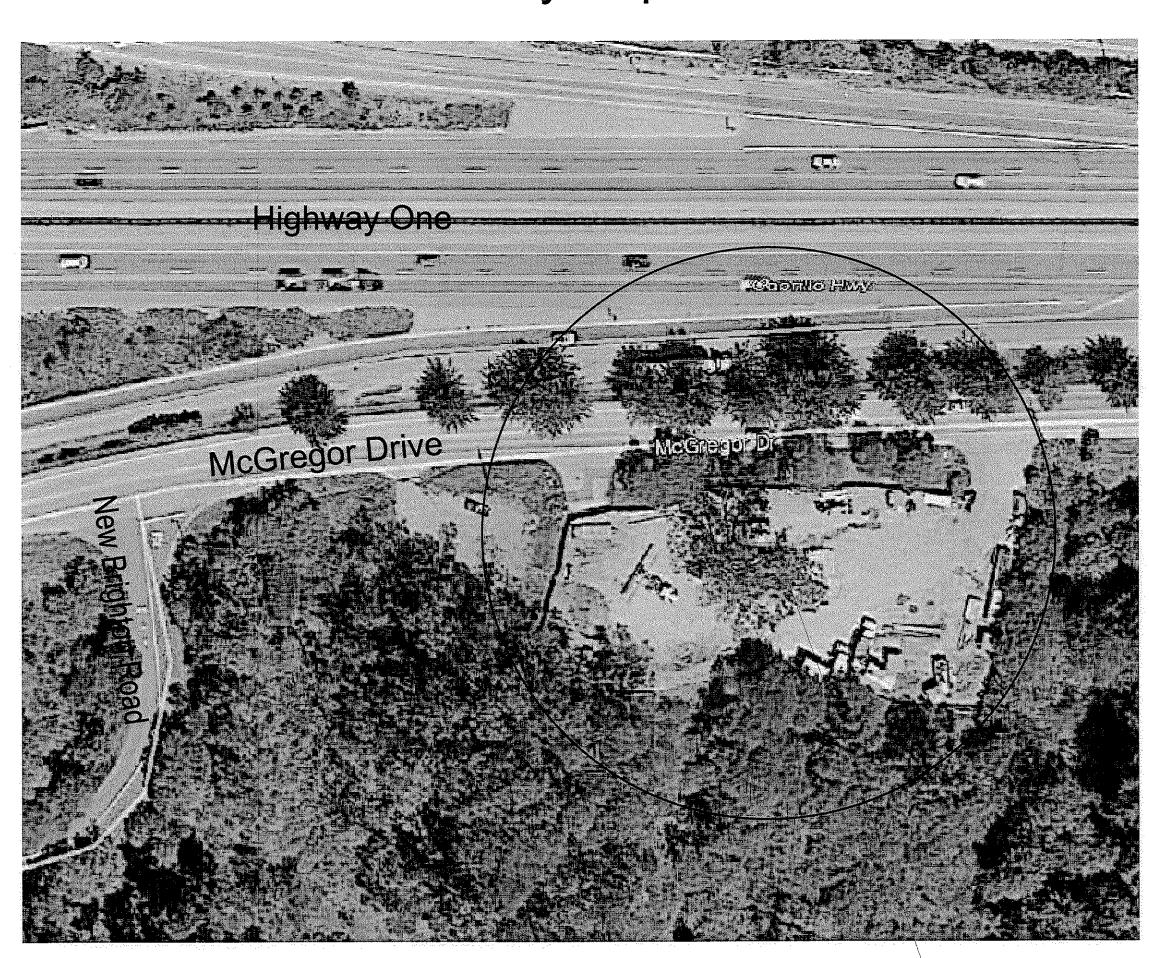
L - 3.1 East Planting Plan

L - 4.0 West Irrigation Plan

L - 4.1 East Irrigation Plan

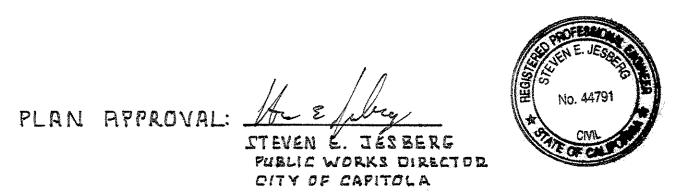
L - 5.0 Planting + Irrigation Details

## Vicinity Map

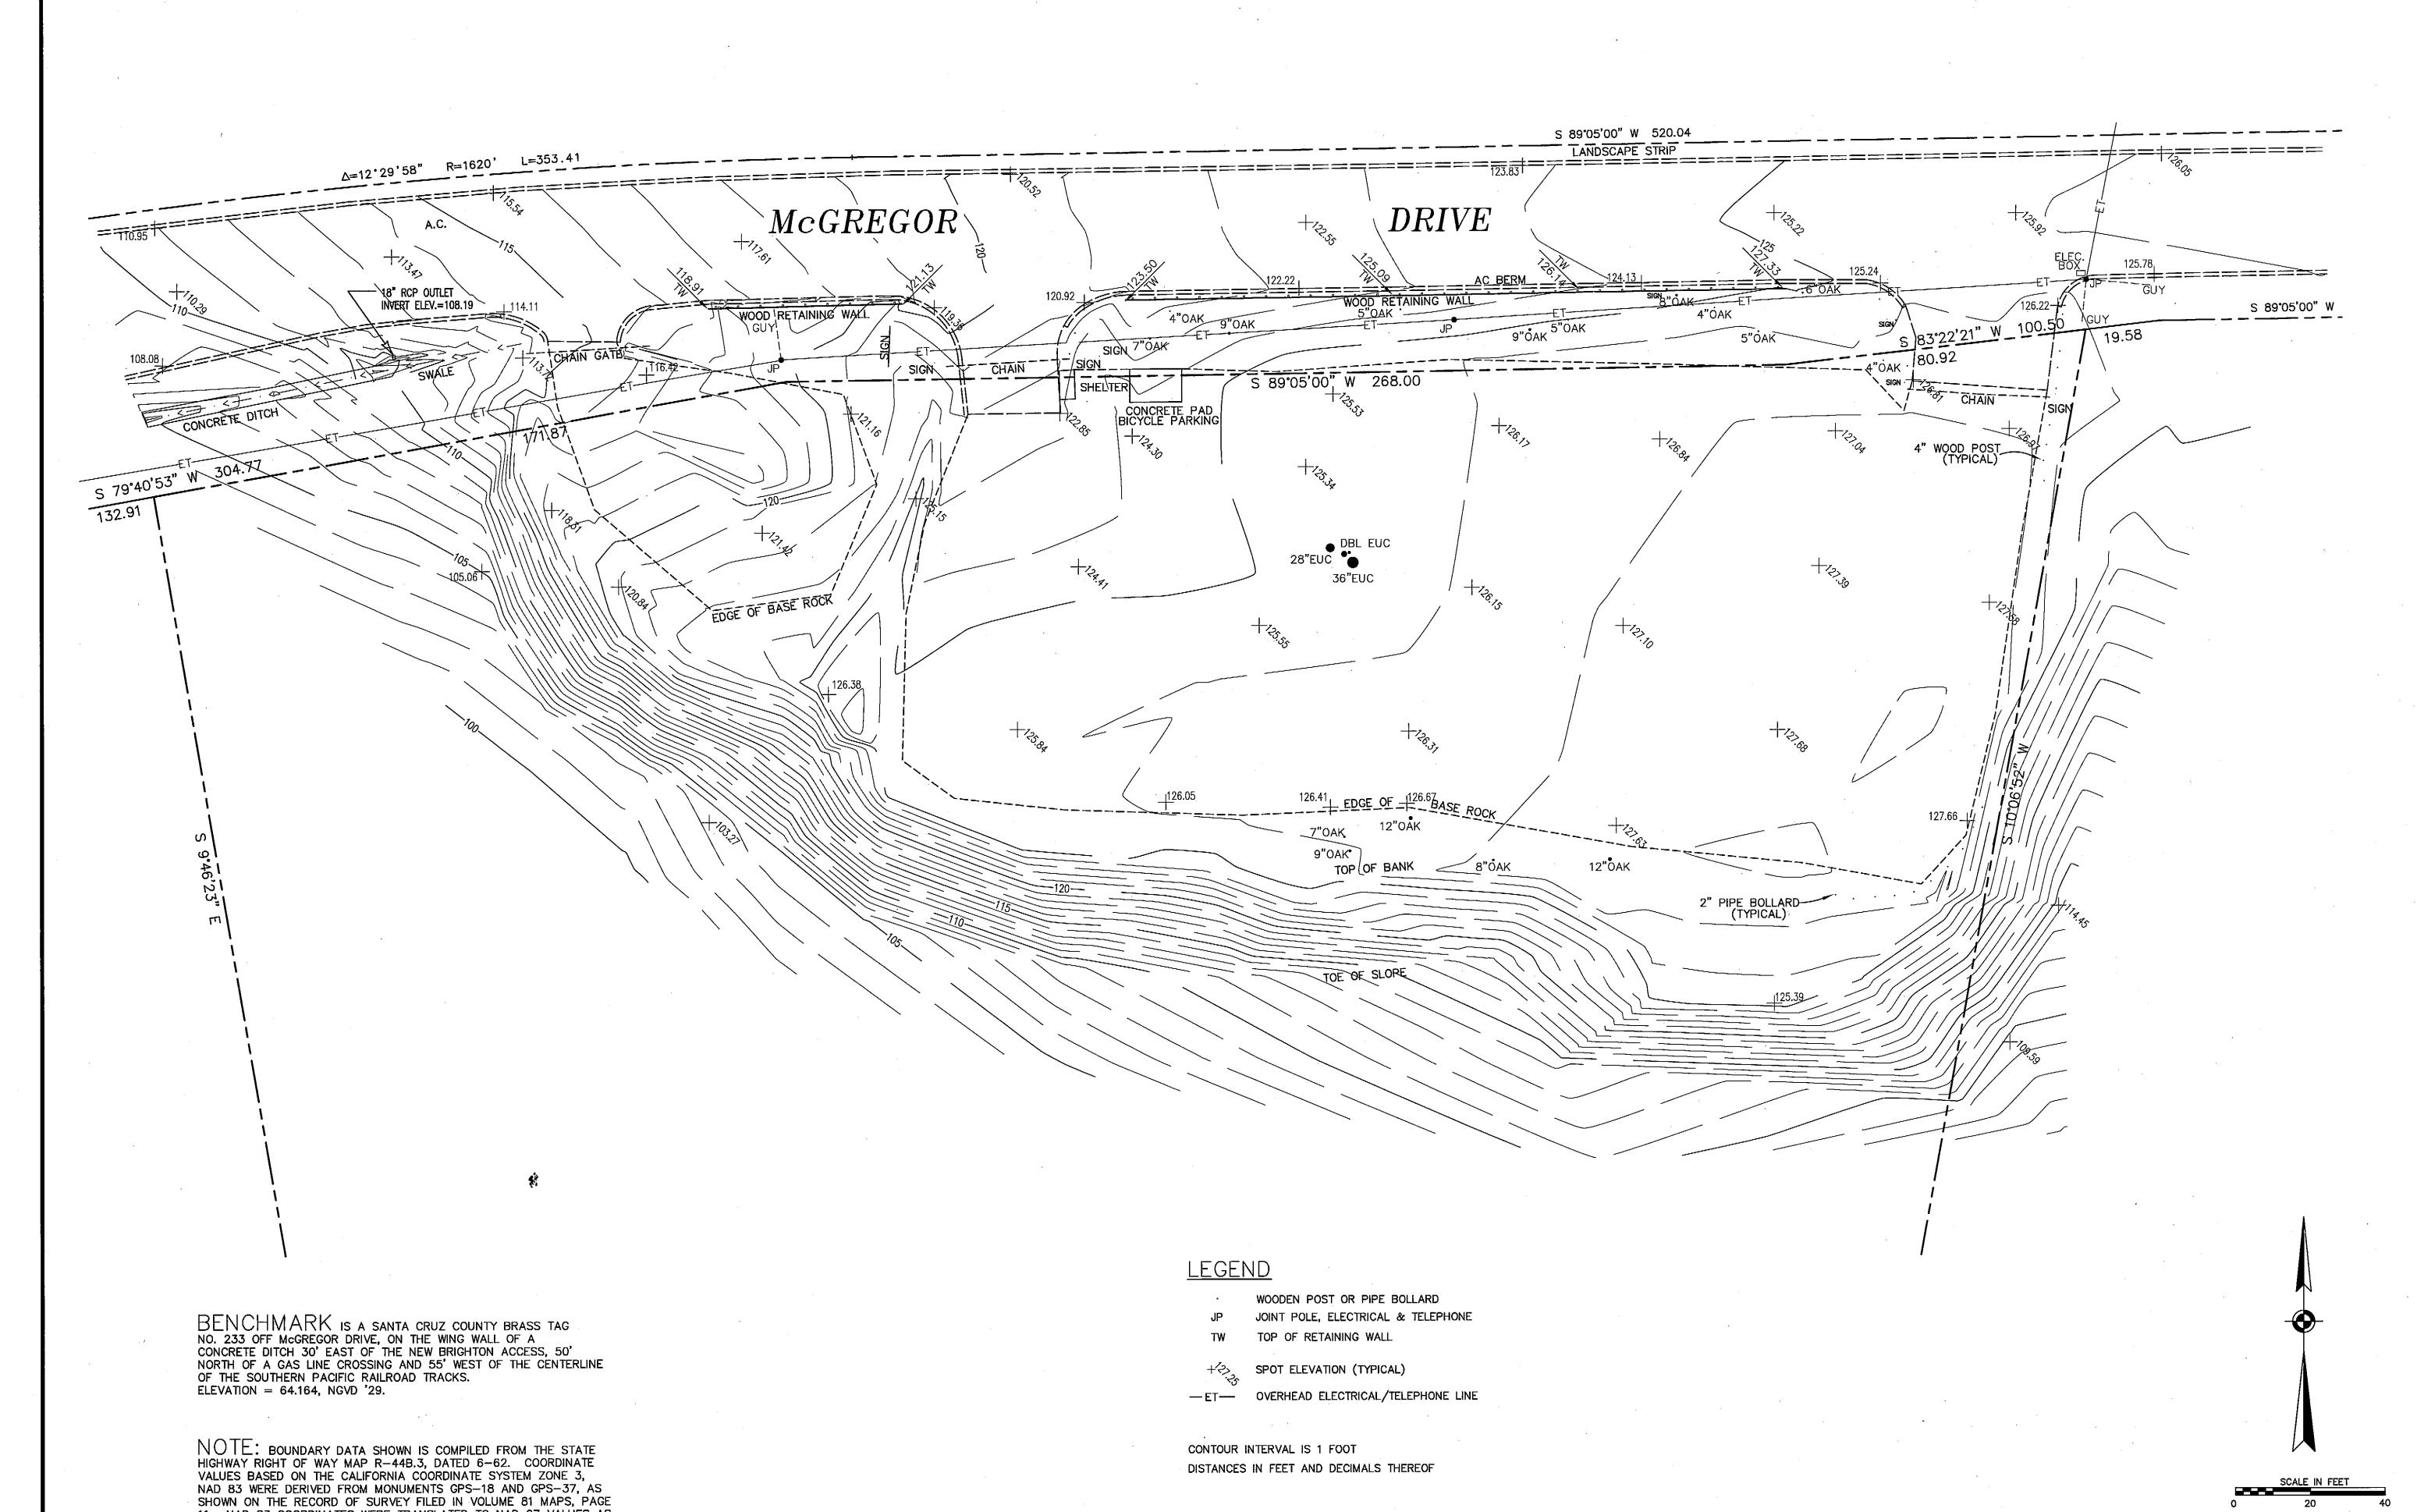


Park Location





## STATE HIGHWAY ROUTE 1



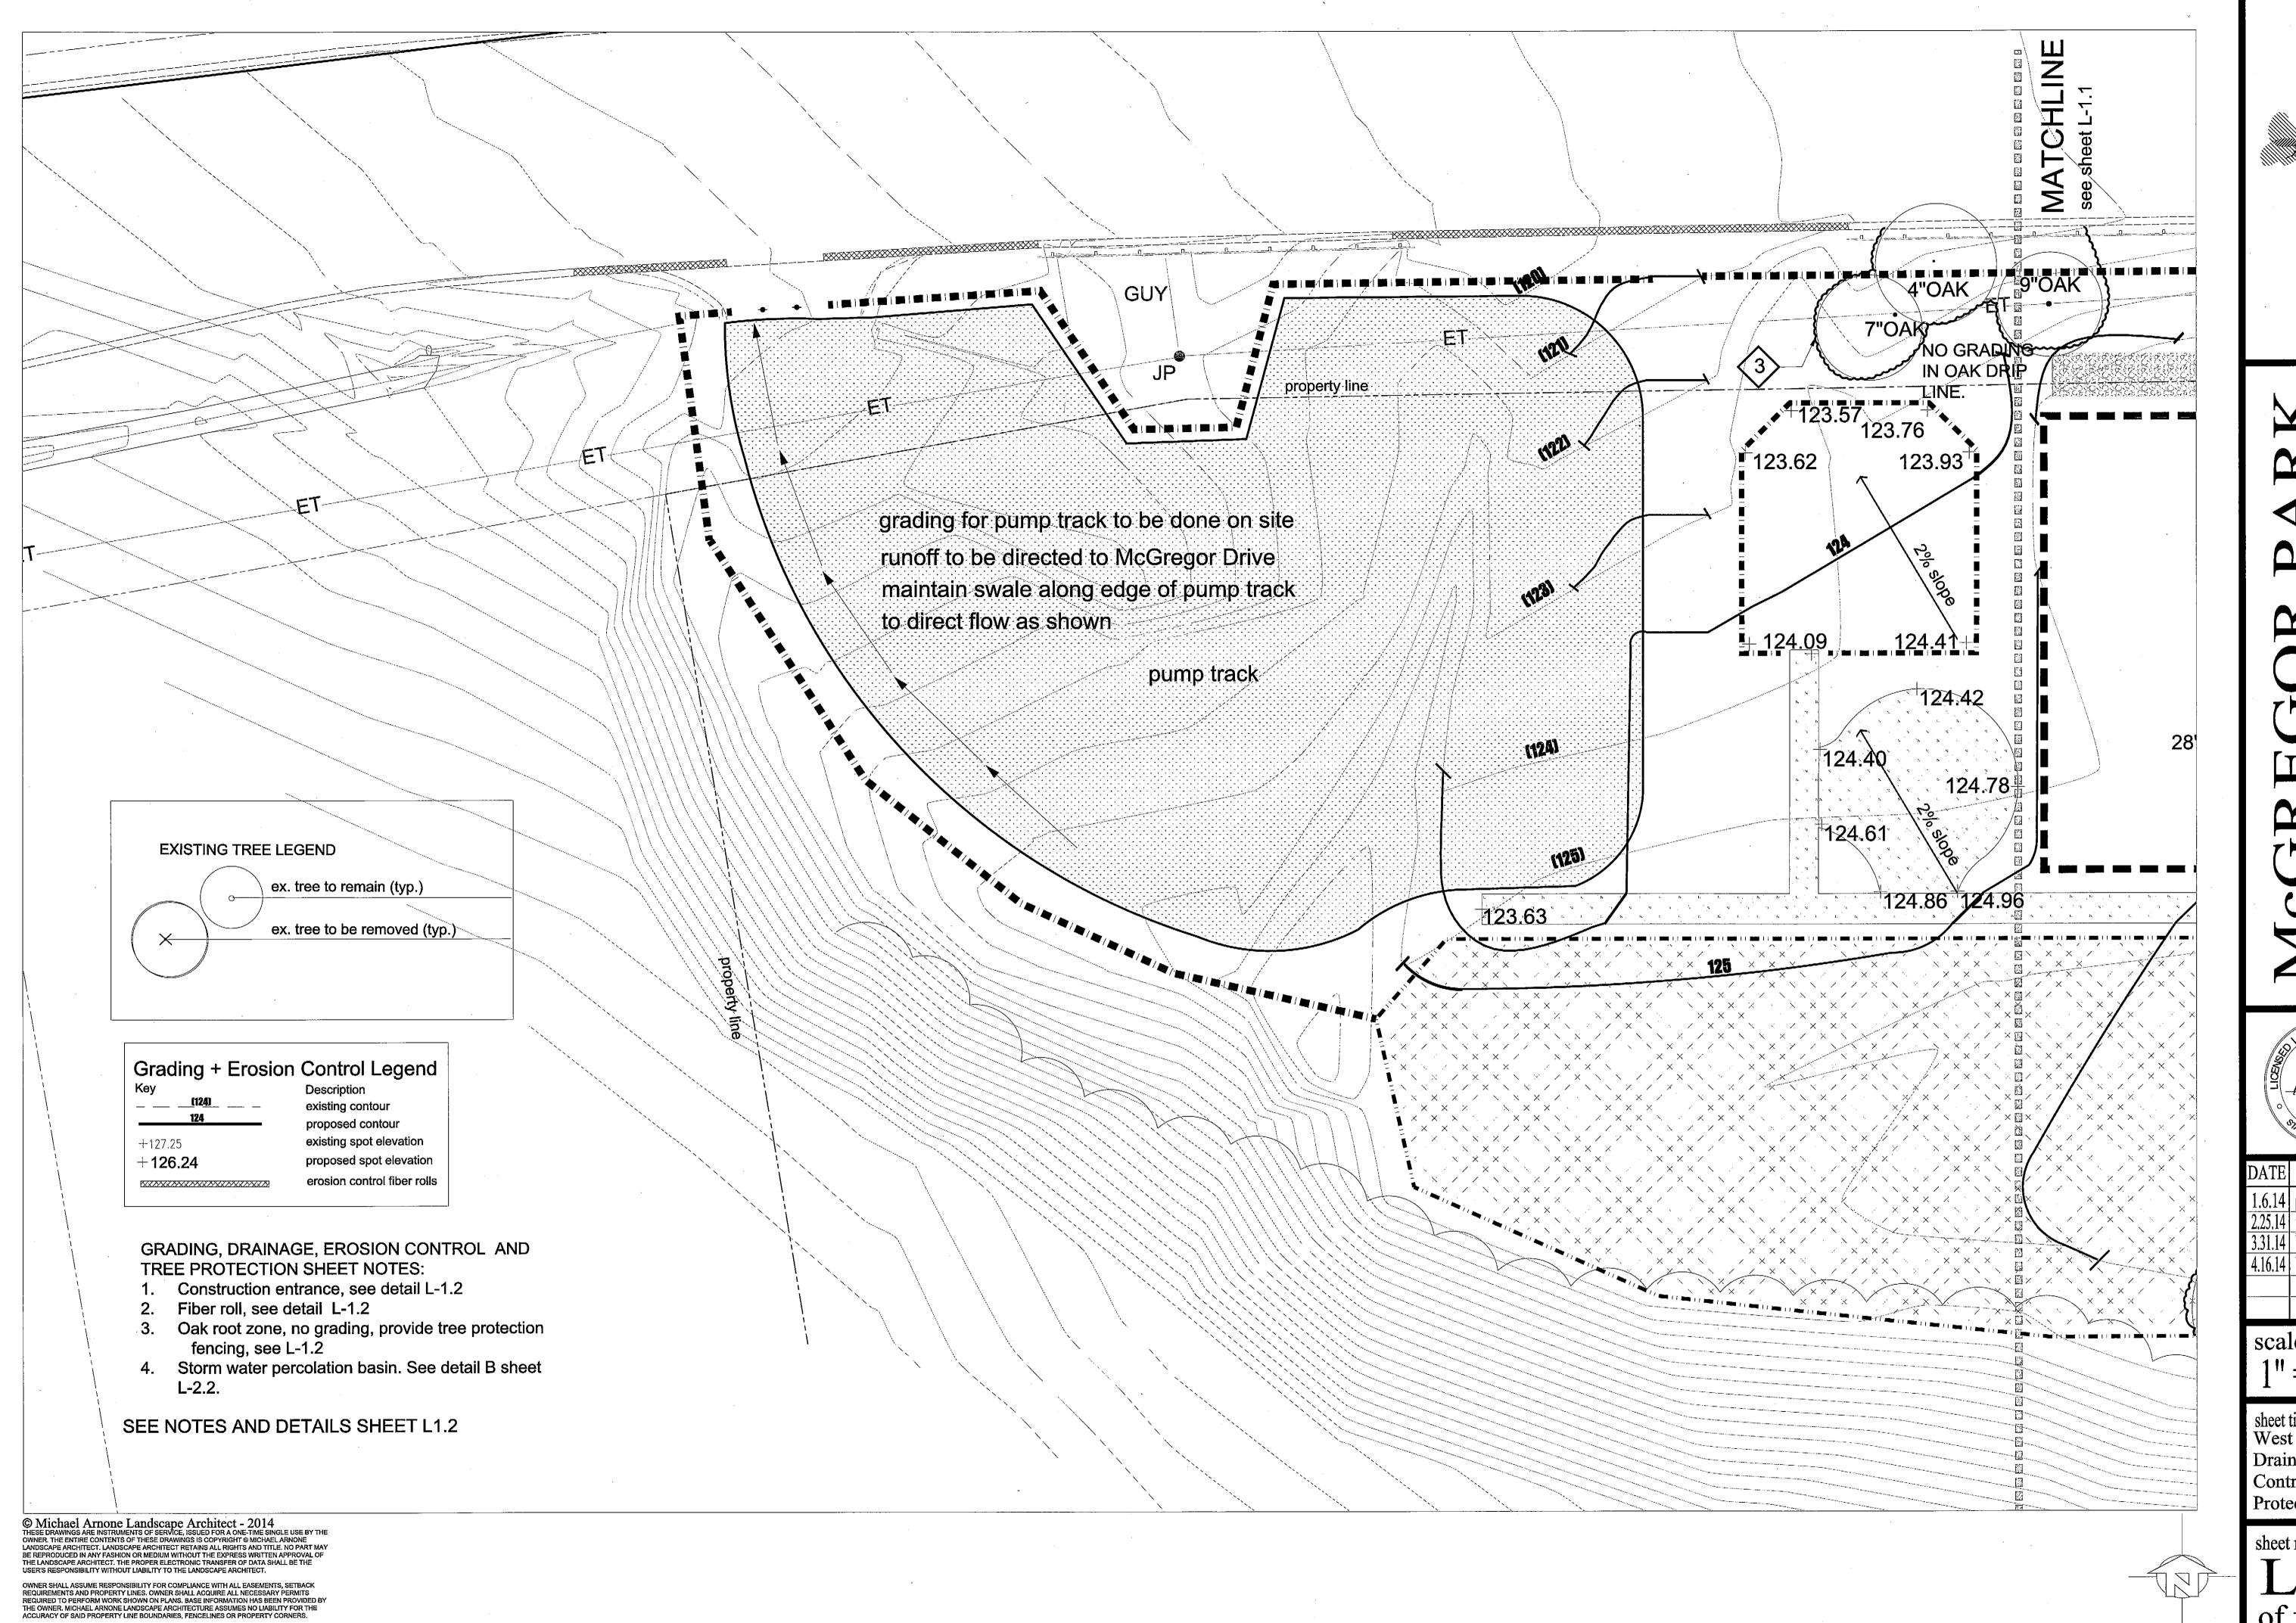
11. NAD 83 COORDINATES WERE TRANSLATED TO NAD 27 VALUES AS

SHOWN ON THE HIGHWAY MAP USING CORPSCON V3.01.

DESIGNED BY: 01/17/1997

**REVISED:** 08/02/2013

SHEETS



S + Associate
CHITECTURE
Inta Cruz, CA 95062

Ael Arnone + Ass

AKK Michael A

MCGREGOR PARI CITY OF CAPITOL

MICHAEL A.
ARNONE

No. 3347
(Exp 7/31/14)

Orane Of Callifornia

DATE PURPOSE BY

1.6.14 panns commission submittal MAA

2.25.14 pod placement MAA

3.31.14 bid set MAA

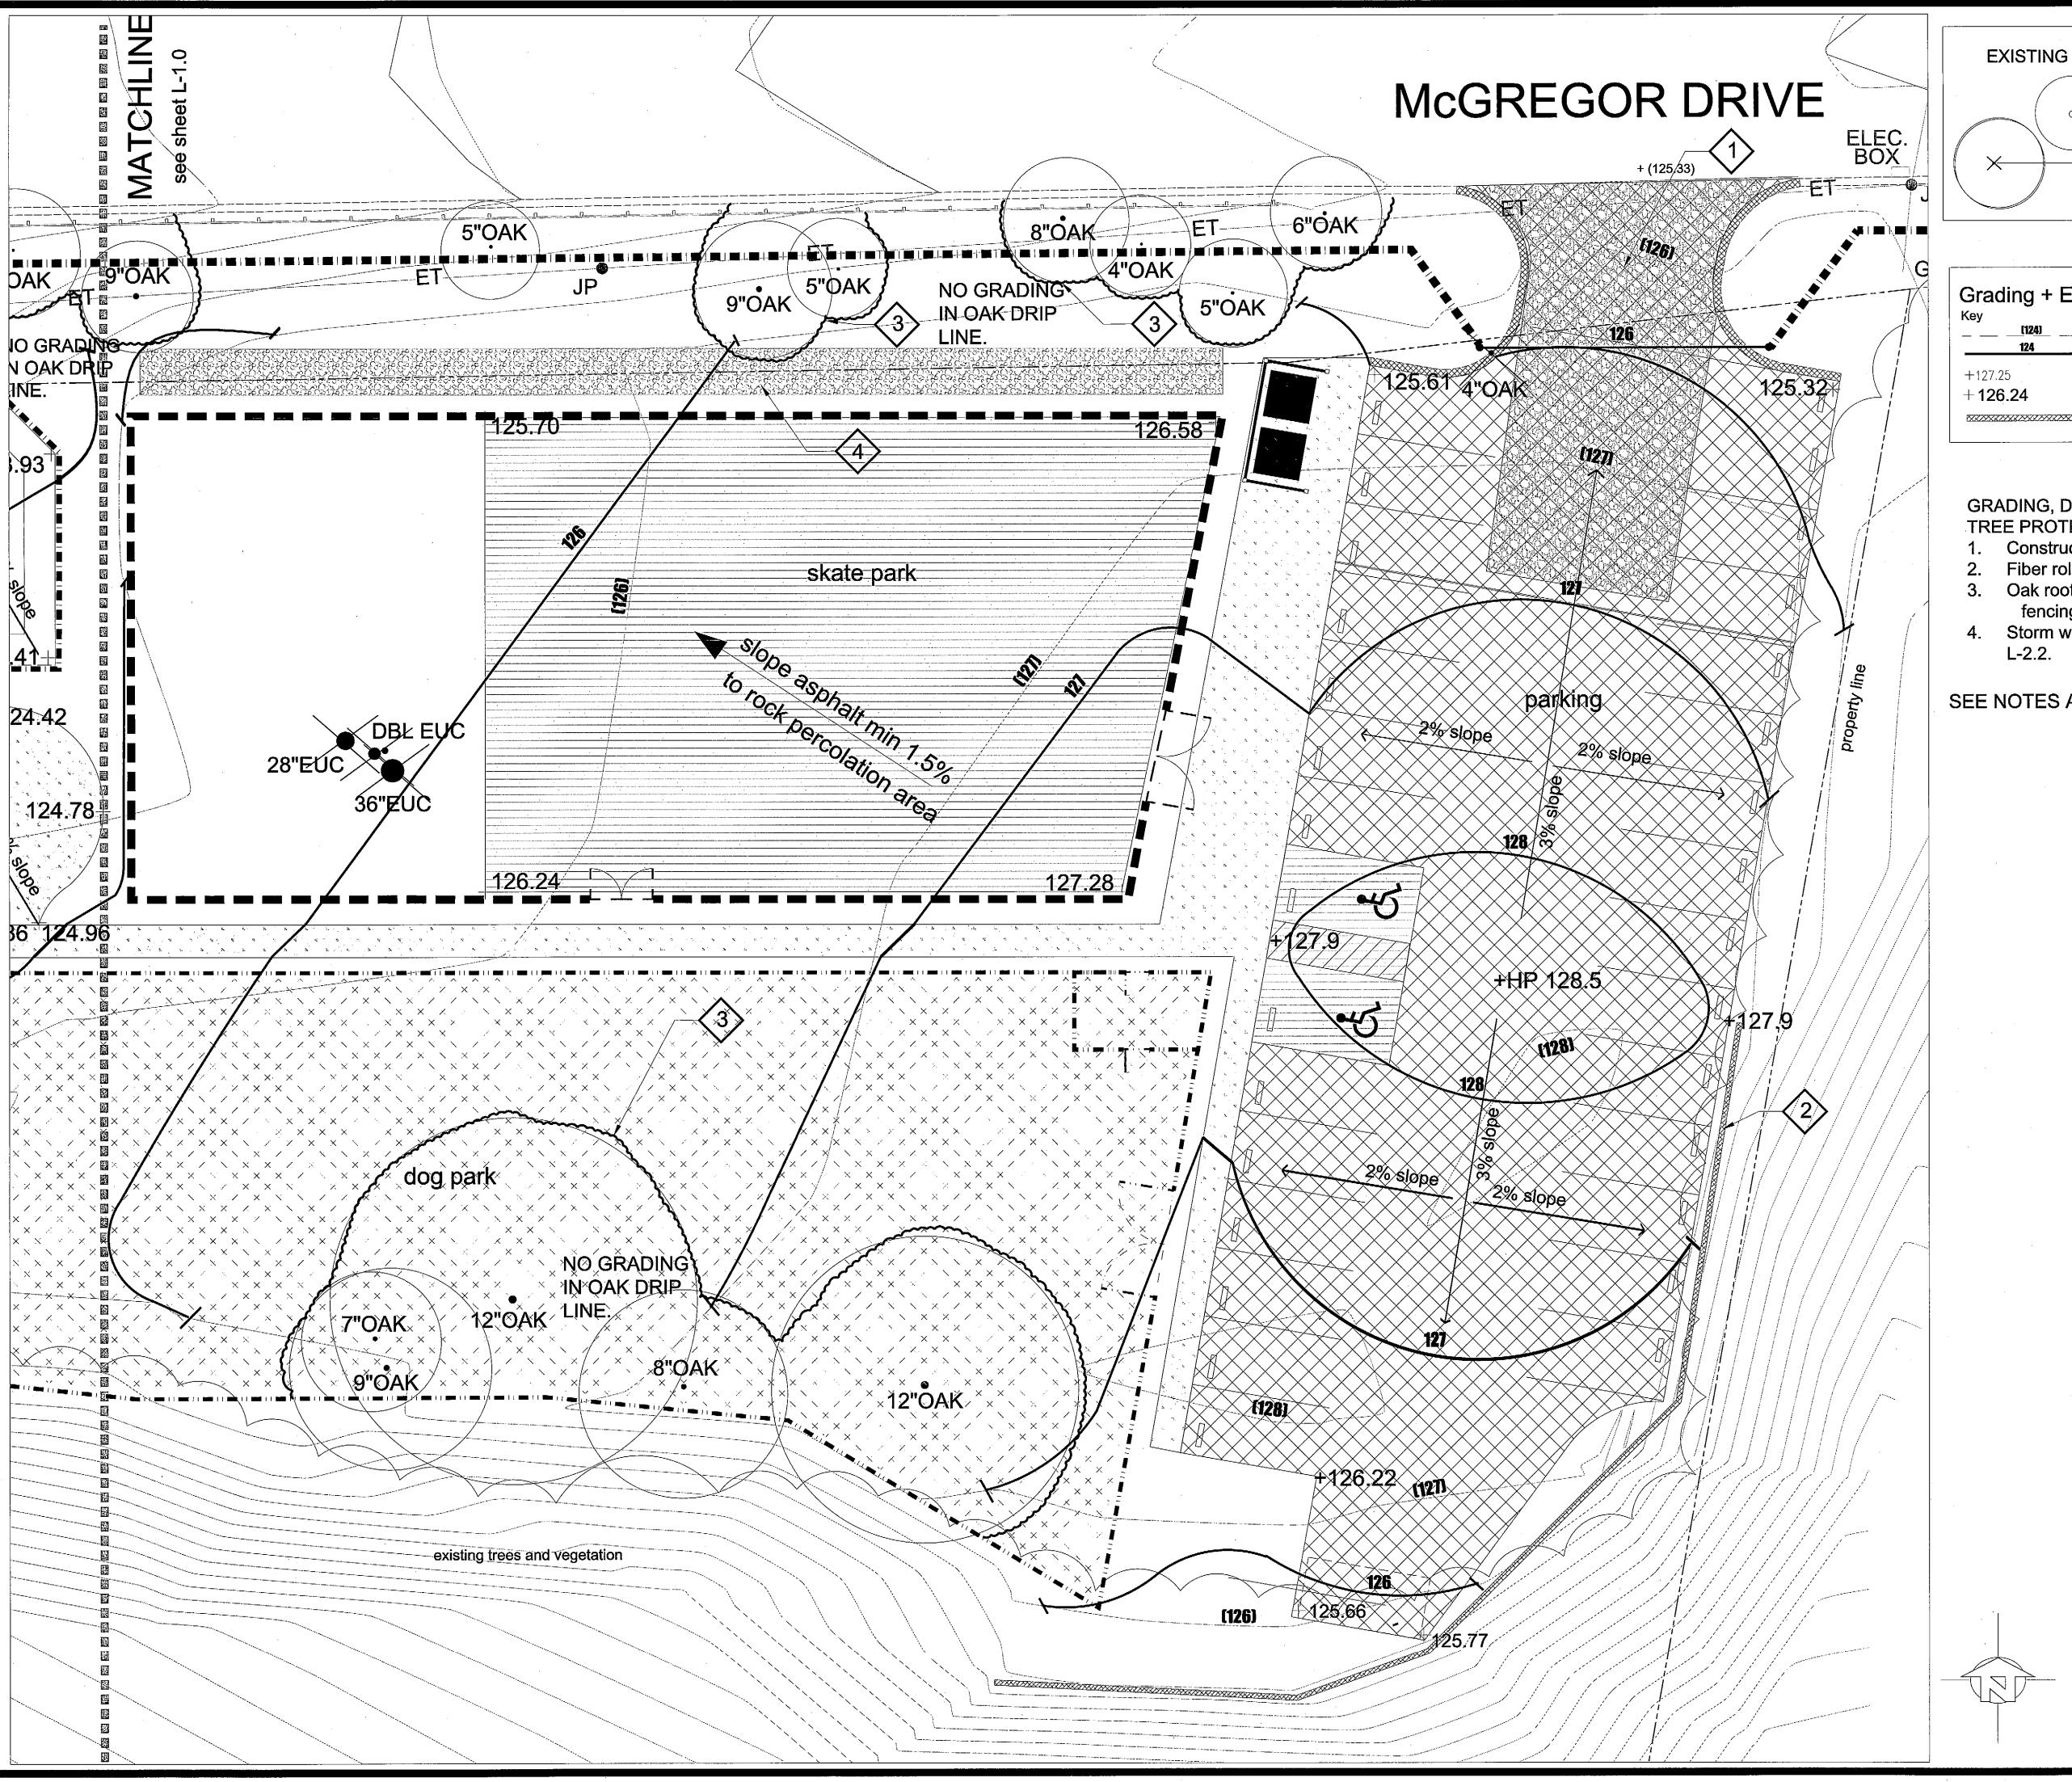
4.16.14 bid set MAA

scale: 1'' = 10' - 0

sheet title:
West Grading +
Drainage, Erosion
Control, Tree
Protection Plan

sheet number:

L-1.0 of fourteen



**EXISTING TREE LEGEND** 

ex. tree to remain (typ.)

ex. tree to be removed (typ.)

Grading + Erosion Control Legend

Description existing contour

proposed contour existing spot elevation proposed spot elevation

## GRADING, DRAINAGE, EROSION CONTROL AND TREE PROTECTION SHEET NOTES:

- Construction entrance, see detail L-1.2
- Fiber roll, see detail L-1.2
- Oak root zone, no grading, provide tree protection fencing, see L-1.2
- 4. Storm water percolation basin. See detail B sheet

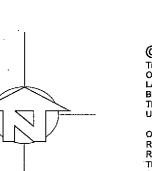
SEE NOTES AND DETAILS SHEET L1.2

3.31.14 bid set MAA 4.16.14 bid set MAA

scale:

sheet title: East Grading + Drainage, Erosion Control, Tree Protection Plan

of fourteen



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**EROSION CONTROL NOTES:** 

- The intention of the erosion control measures shown on this plan are for interim erosion and sediment control only. All erosion control measures shall conform to California Regional Water Quality Control's Field Manual for Erosion and Sedimentation Control, The California Storm Water Quality Association Best Management Practices Handbook for Construction and the local governing agency for the project. 2. No land clearing, grading, or excavation shall be done between October
- 15th and April 15th. 3. The Contractor shall be responsible for implementing and maintaining
- site erosion control at all times.
- 4. The Contractor shall be responsible for checking and repairing erosion control systems after storm events and in the event of damage from construction processes.
- 5. Measures shall be taken to collect and clean any accumulation of dirt, mud, sand, gravel or rocks on the surface of any street. Removal shall be done with street sweepers or hand sweeping. Water shall not be used to wash sediments into public or private drainage systems.
- 6. Unnecessary grading and disturbing of soil shall be avoided. Between October 15th and April 15th exposed soil shall be protected from erosion at all times .Hay bales, fiber berms, silt fences or other means shall be employed to prevent sediment from leaving the site and entering any watercourse.
- 8. During construction, no turbid water shall be permitted to enter the channel or storm drain system. Use of silt or grease traps, filter berms, hay bales or silt fences shall be used to prevent such discharge.
- 9. Construction entrances shall be installed prior to commencement of grading. All construction traffic entering on to the paved roads must cross the stabilized construction entrances. Contractor shall maintain a stabilized entrance at each entrance to a paved street. Any mud or debris tracked onto the public streets shall be removed daily.
- 10. All areas on- and off-site exposed during construction activities, if not permanently landscaped per plan, shall be protected by mulching and/or planting of the following SCS approved erosion control mix at a rate of 35lbs. per acre.

Blando Brome Rose Clover (pellet innoculated) 35% Creeping Red Fescue

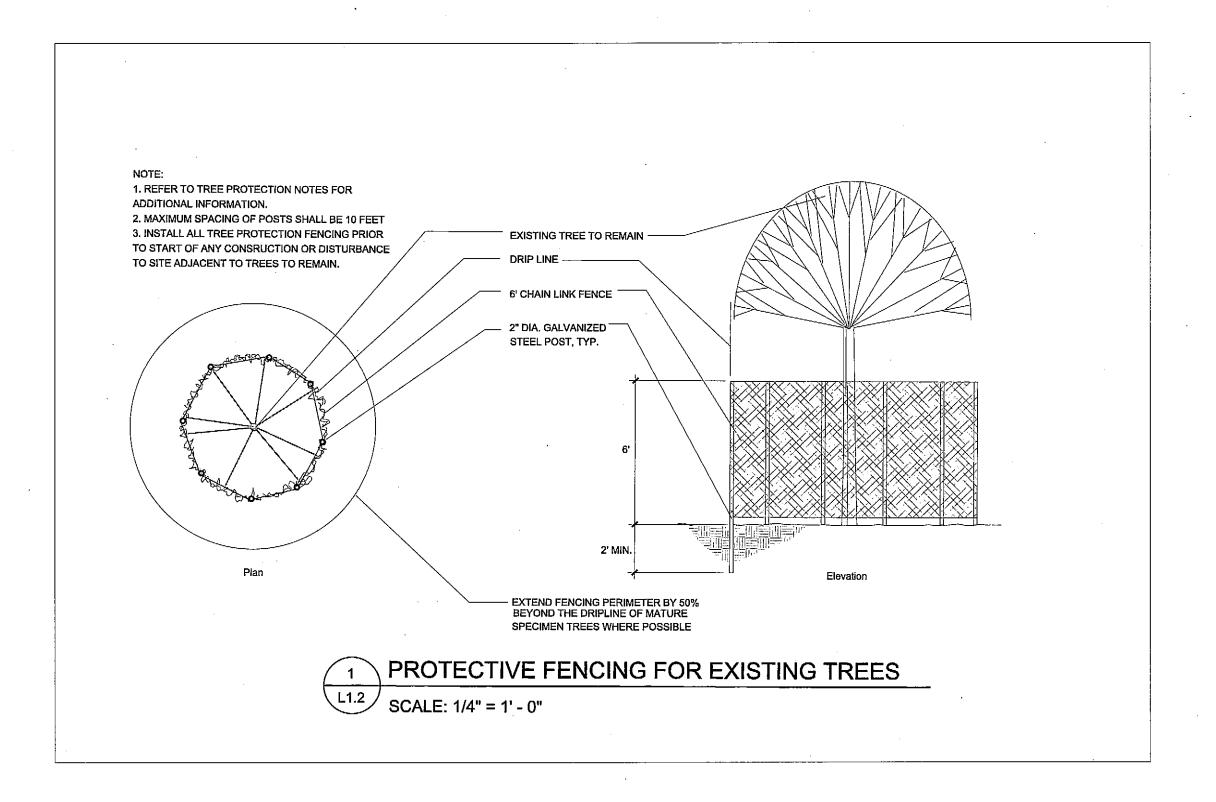
- Zorro Annual Fescue Trace 11. All excavated material shall be removed to an approved disposal site or disposed of on-site in a manner that will not cause erosion.
- 12. Any material stockpiled on-site shall be covered with plastic during the winter months or during periods of rain.
- 13. Exposed soil on slopes greater than 20% shall be seeded, covered with 2" of straw, and an erosion control blanket. The erosion control blanket shall be staked in place.
- 14. Fiber rolls shall be placed along the top of the down slope perimeter as shown by symbol on plan. Placement shall run with contours and rolls shall be tightly end butted. Contractor shall refer to manufacturers specifications for placement and installation instructions.
- 15. The Contractor shall be responsible for seeing that additional measures necessary to control site erosion and prevent sediment transport off-site are implemented.

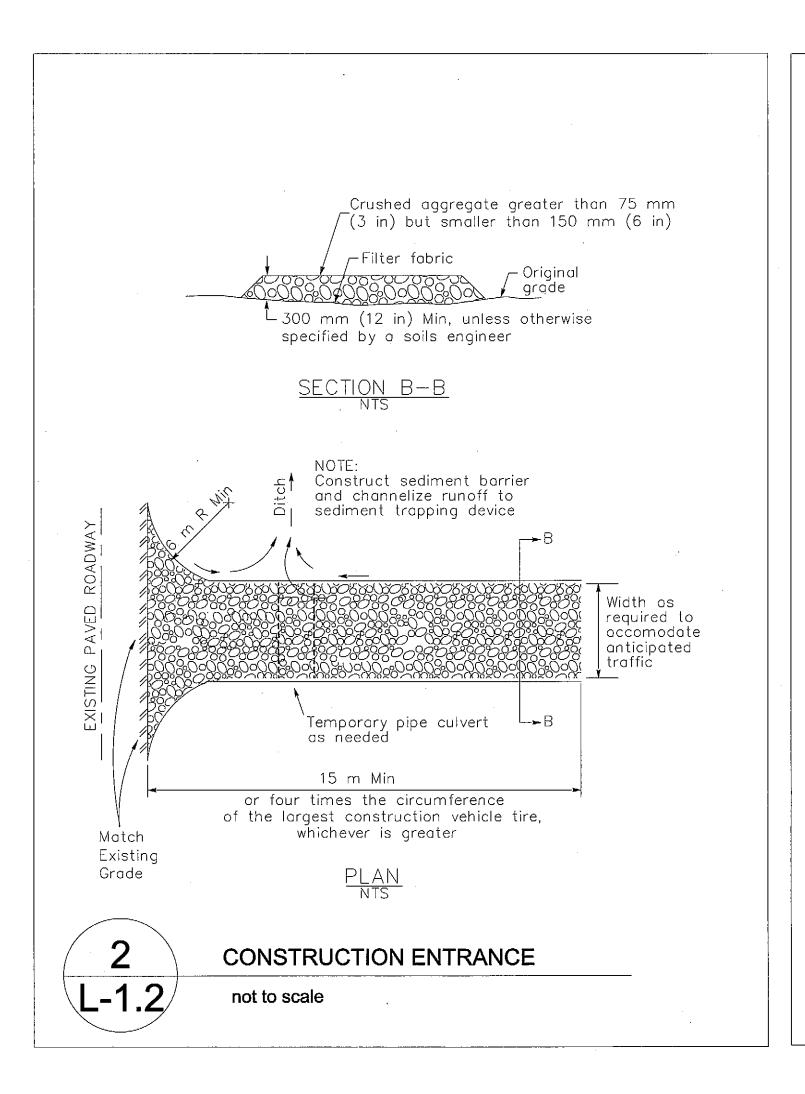
TREE PROTECTION NOTES:

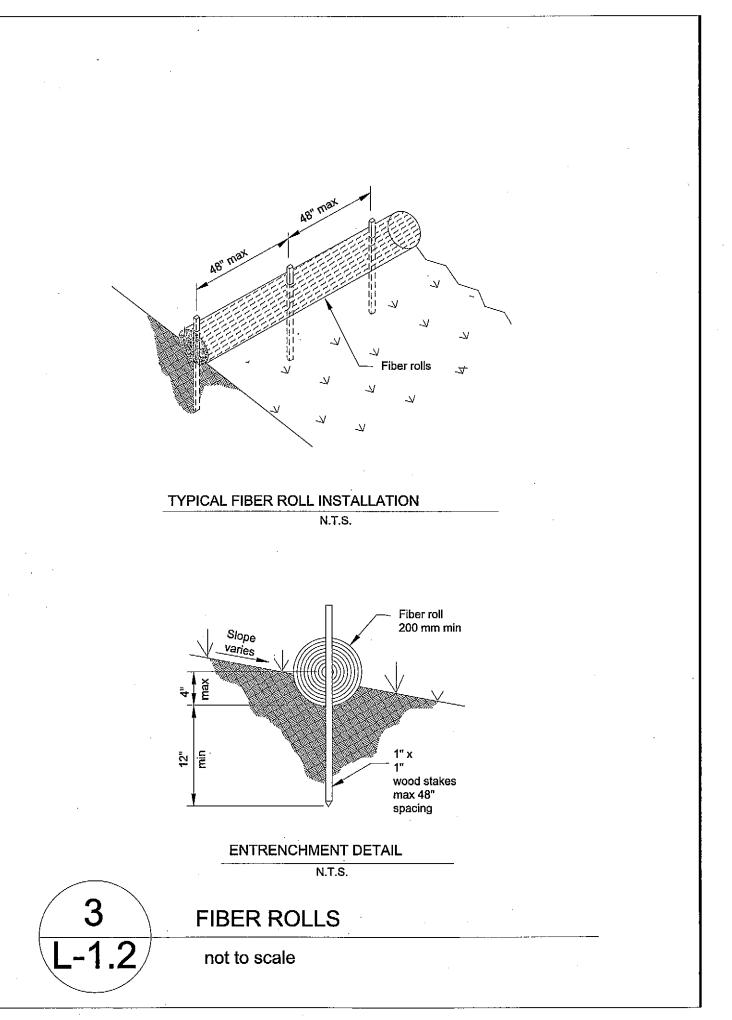
- 1. Prior to initiating any construction activity in the area, including grading, temporary fencing shall be installed at each site tree. Fencing shall be located at or beyond the canopy drip line so that 100% of the drip line will be protected by fencing. To reduce soil compaction from equipment, a mulch of 1-2 inch sized wood chips shall be placed at a depth of 4 inches where no excavation is to occur in the vicinity of the trees to be protected.
- 2. The tree protection fence shall be 6' high chain link with immovable posts. The fencing shall form a continuous barrier without entry points around each tree. Any encroachment into the drip line for fencing or construction purposes shall not be permitted.
- 3. Low hanging limbs of saved trees shall be pruned prior to grading, or any equipment mobilization on site. The purpose of this requirement is to avoid tearing limbs by heavy equipment. All limbs to be pruned shall be supervised by the arborist of record for the job.
- 4. This fencing shall serve as a barrier to prevent drip line encroachment of any type of construction activities and equipment. No oils, gas, chemicals, liquid waste, solid waste, construction machinery or construction materials shall be stored or allowed to stand for any period of time within the drip line of the tree. Further, no one shall enter the fence perimeter for any reason except for the purpose of monitoring the health of the tree. Accidental damage to bark, root crown, or limbs may increase the potential for future decline in the health of the tree.
- 5. Contractors and subcontractors shall direct all equipment and personnel to remain outside the fenced area and at all times until the project is complete, and shall instruct employees as to the purpose and importance of fencing.
- 6. A warning sign shall be posted at each tree indicating the purpose of the fencing.
- 7. The arborist of record for the job and or the city arborist shall be responsible for inspection and approval of the fencing prior to any grading operations.
- 8. Fencing must remain in place and shall not be removed until all construction activities are completed. This shall include grading and compaction activities, installation of underground utilities, all construction activities, and any other construction or activity that is scheduled prior to landscape installation.
- 9. Roots of single standing trees often extend up the to three times the distance of the actual drip line and function primarily in the uptake of nutrients and water. The drip line is arbitrarily established as the minimum root area generally required to preserve tree health. As much area around the circumference of the tree should have minimum intrusion to further insure tree survival and health.
- 10. Unauthorized tree removal is subject to in-kind replacement equal to the mature resource lost as determined by the city.
- 11. The contractor is required to water, fertilize and attend to other maintenance needs of existing trees as needed per arborist's recommendations to maintain healthy growth throughout the construction period. Six foot diameter minimum by six inch tall earth berms shall be constructed at the base of each tree to function as temporary watering basins during the construction period. Trees shall be watered according to weather and tree requirements.

## **GRADING and DRAINAGE NOTES:**

- All grading shall be done in conformance with Capitola Municipal Code Chapter 13.16, Storm Water Pollution Prevention and Protection.
- 2. Vegetation, roots and deleterious materials shall be removed from area to be graded prior to grading.
- 3. Cut and fill slopes shall be 3:1 maximum or flatter no exceptions.
- 4. Dirt, strippings or structural fill will not be allowed to move on or off-site, through public rights-of-way or streets by non-licensed or off-road vehicles.
- 5. Fill shall be compacted to 90% relative compaction unless otherwise noted.
- 6. After grading, spread topsoil from strippings and landscaped areas 3" to 6" deep.







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Michael A

No. 3347 (Exp 7/31/14) DATE PURPOSE 2.25.14 pod placement MAA

3.31.14 bid set MAA

4.16.14 bid set MAA

MICHAEL A.

scale: as noted

sheet title:

Grading + Drainage, Erosion Control, Tree Protection Notes and Details

sheet number:

of fourteen

LAYOUT AND MATERIALS SHEET NOTES: 1. Form and pour new asphalt curbs for new entry. 2. Vehicle gate re-use existing. 3. Portable restroom to be provided by other. 4. 8" High wooden screen: see detail K sheet L-2.2 5. Solar powered LED light: see schedule this sheet 6. Bike racks: see schedule this sheet 7. Trash recycling receptacles: see schedule this sheet 8. Drinking fountain: see schedule this sheet, install as per manufact. instructions 9. Dog clean-up station:see schedule this sheet 10. Decomposed granite path: see detail A sheet L-2.2 11. Service access gates12. Benches: see schedule this sheet 13. Kids play area: see detail L sheet L-2.2 14. Two seat game table: see schedule this sheet 15. sleeve under paving (typical) 16. Form and pour new asphalt curb.

19. Openings in fence, 13'-0" wide with removable bollards on west entry, 6' wide on east entry (no bollards). See bollard detail M sheet L-2.2. 20. Donor Sign: see detail H sheet L-2.2 21. Drinking fountain percolation pit: 16" diameter, 3' deep filled with 3/4" drain rock. Connect drain line from fountain to pit. 22. Planned location of recycling pod.

17. Form and pour new asphalt curb leave opening 13' wide for

18.Storm water percolation basin. See detail B sheet L-2.2.

vehicle at service access gate.

**CONSTRUCTION NOTES:** 1. Contractor shall notify Underground Service Alert (USA) at

800.642.2444 to verify the location and depth of all existing utilities prior to any demolition, trenching or excavation.

2. All spoils and debris from the demolition work shall be hauled off site and disposed of in a lawful manner as part of the Contractor's site and demolition work. 3. Contractors shall review all related work required on all other

construction. 4. Contractor shall take care not to damage in any way, any existing elements to remain. Such damage is the responsibility of the contractor and shall be replaced or repaired to match the original at no additional

cost to the owner. 5. All dimensions and elevations shall be verified in the field and chalked, flagged or string lined prior to any construction. If any discrepencies occur, notify Landscape Architect immediately before proceeding.

KEY .	DESCRIPTION	MANUFACTURER	MODEL#	COLOR/FINISH/MOUNT	QUANTITY	CONTACT
	BIKE RACK SINGLE SIDE ENTRY, 9 OPENINGS	DuMor	81-10	BLACK BOLT TO CONCRETE FOOTING	3	dumor.com caseyh@rossrec.com
0	TRASH RECEPTACLE 32 GALLON W/ LINER & DOME LID	PARK N POOL	11RE-00006 11AC-00022 11RE-00006	GRAY RECEPTACLE & LID ANCHOR TO CONCRETE FOOTING	3	parknpool.com
0	RECYCLING RECEPTACLE 32 GALLON W/ LINER & DOME LID	PARK N POOL	11RE-00006 11AC-00022 11RE-00006	MYSTIC BLUE RECEPTACLE & LID ANCHOR TO CONCRETE FOOTING	3	parknpool.com
	BENCH RECYCLED PLASTIC W/ BACK	DuMor	BENCH 165 165-80PL	HUNTER GREEN AND REDWOOD ANCHOR TO CONCRETE FOOTING	2	dumor.com caseyh@rossrec.com
	GAME TABLE 2 SEAT RECYCLED PLASTIC	DuMor	TABLE 78 w/ 2 seats 78-32PL	HUNTER GREEN AND REDWOOD ANCHOR IN CONCRETE FOOTING	1	dumor.com caseyh@rossrec.com
⊕ G⊕	DRINKING FOUNTAIN ADA COMPLIANT W/ DOG BASIN	HAWS	3500 D	CUSTOM BLUE BOLT TO CONCRETE FOOTING SEE MANUFACTURER'S DETAIL	2	hawsco.com caseyh@rossrec.com
Ō	DOG STATION	DOODY CALLS DIRECT	THE GLADIATOR	BLACK ANCHOR TO CONCRETE FOOTING	2	doodycallsdirect.com
•	4" DIA. EXTERNAL LOCKING REMOVABLE BOLLARD	CALPIPE	IBP04040 WITH HALF DOME CAP AND TWO LIFTING HANDLES WITH ANTI-CORROSION COAT FINISH	EXTENDS 36" ABOVE GRADE AND 12" BELOW GRADE - COLOR: FORREST GREEN	2	calpipebollards.com j.pederson@calpipe.d
● T3	SOLAR LED LIGHT FIXTURE ON 12 FOOT POLE	FIRST LIGHT TECHNOLOGIES	IPL SERIES TYPE 3 EMS	BLACK SEE MANUFACTURER'S DETAIL	3	firstiighttechnologies.
<b>●</b> T5	SOLAR LED LIGHT FIXTURE ON 10 FOOT POLE	FIRST LIGHT TECHNOLOGIES	IPL SERIES TYPE 5 EMS	BLACK SEE MANUFACTURER'S DETAIL	2	firstlightlechnologies.

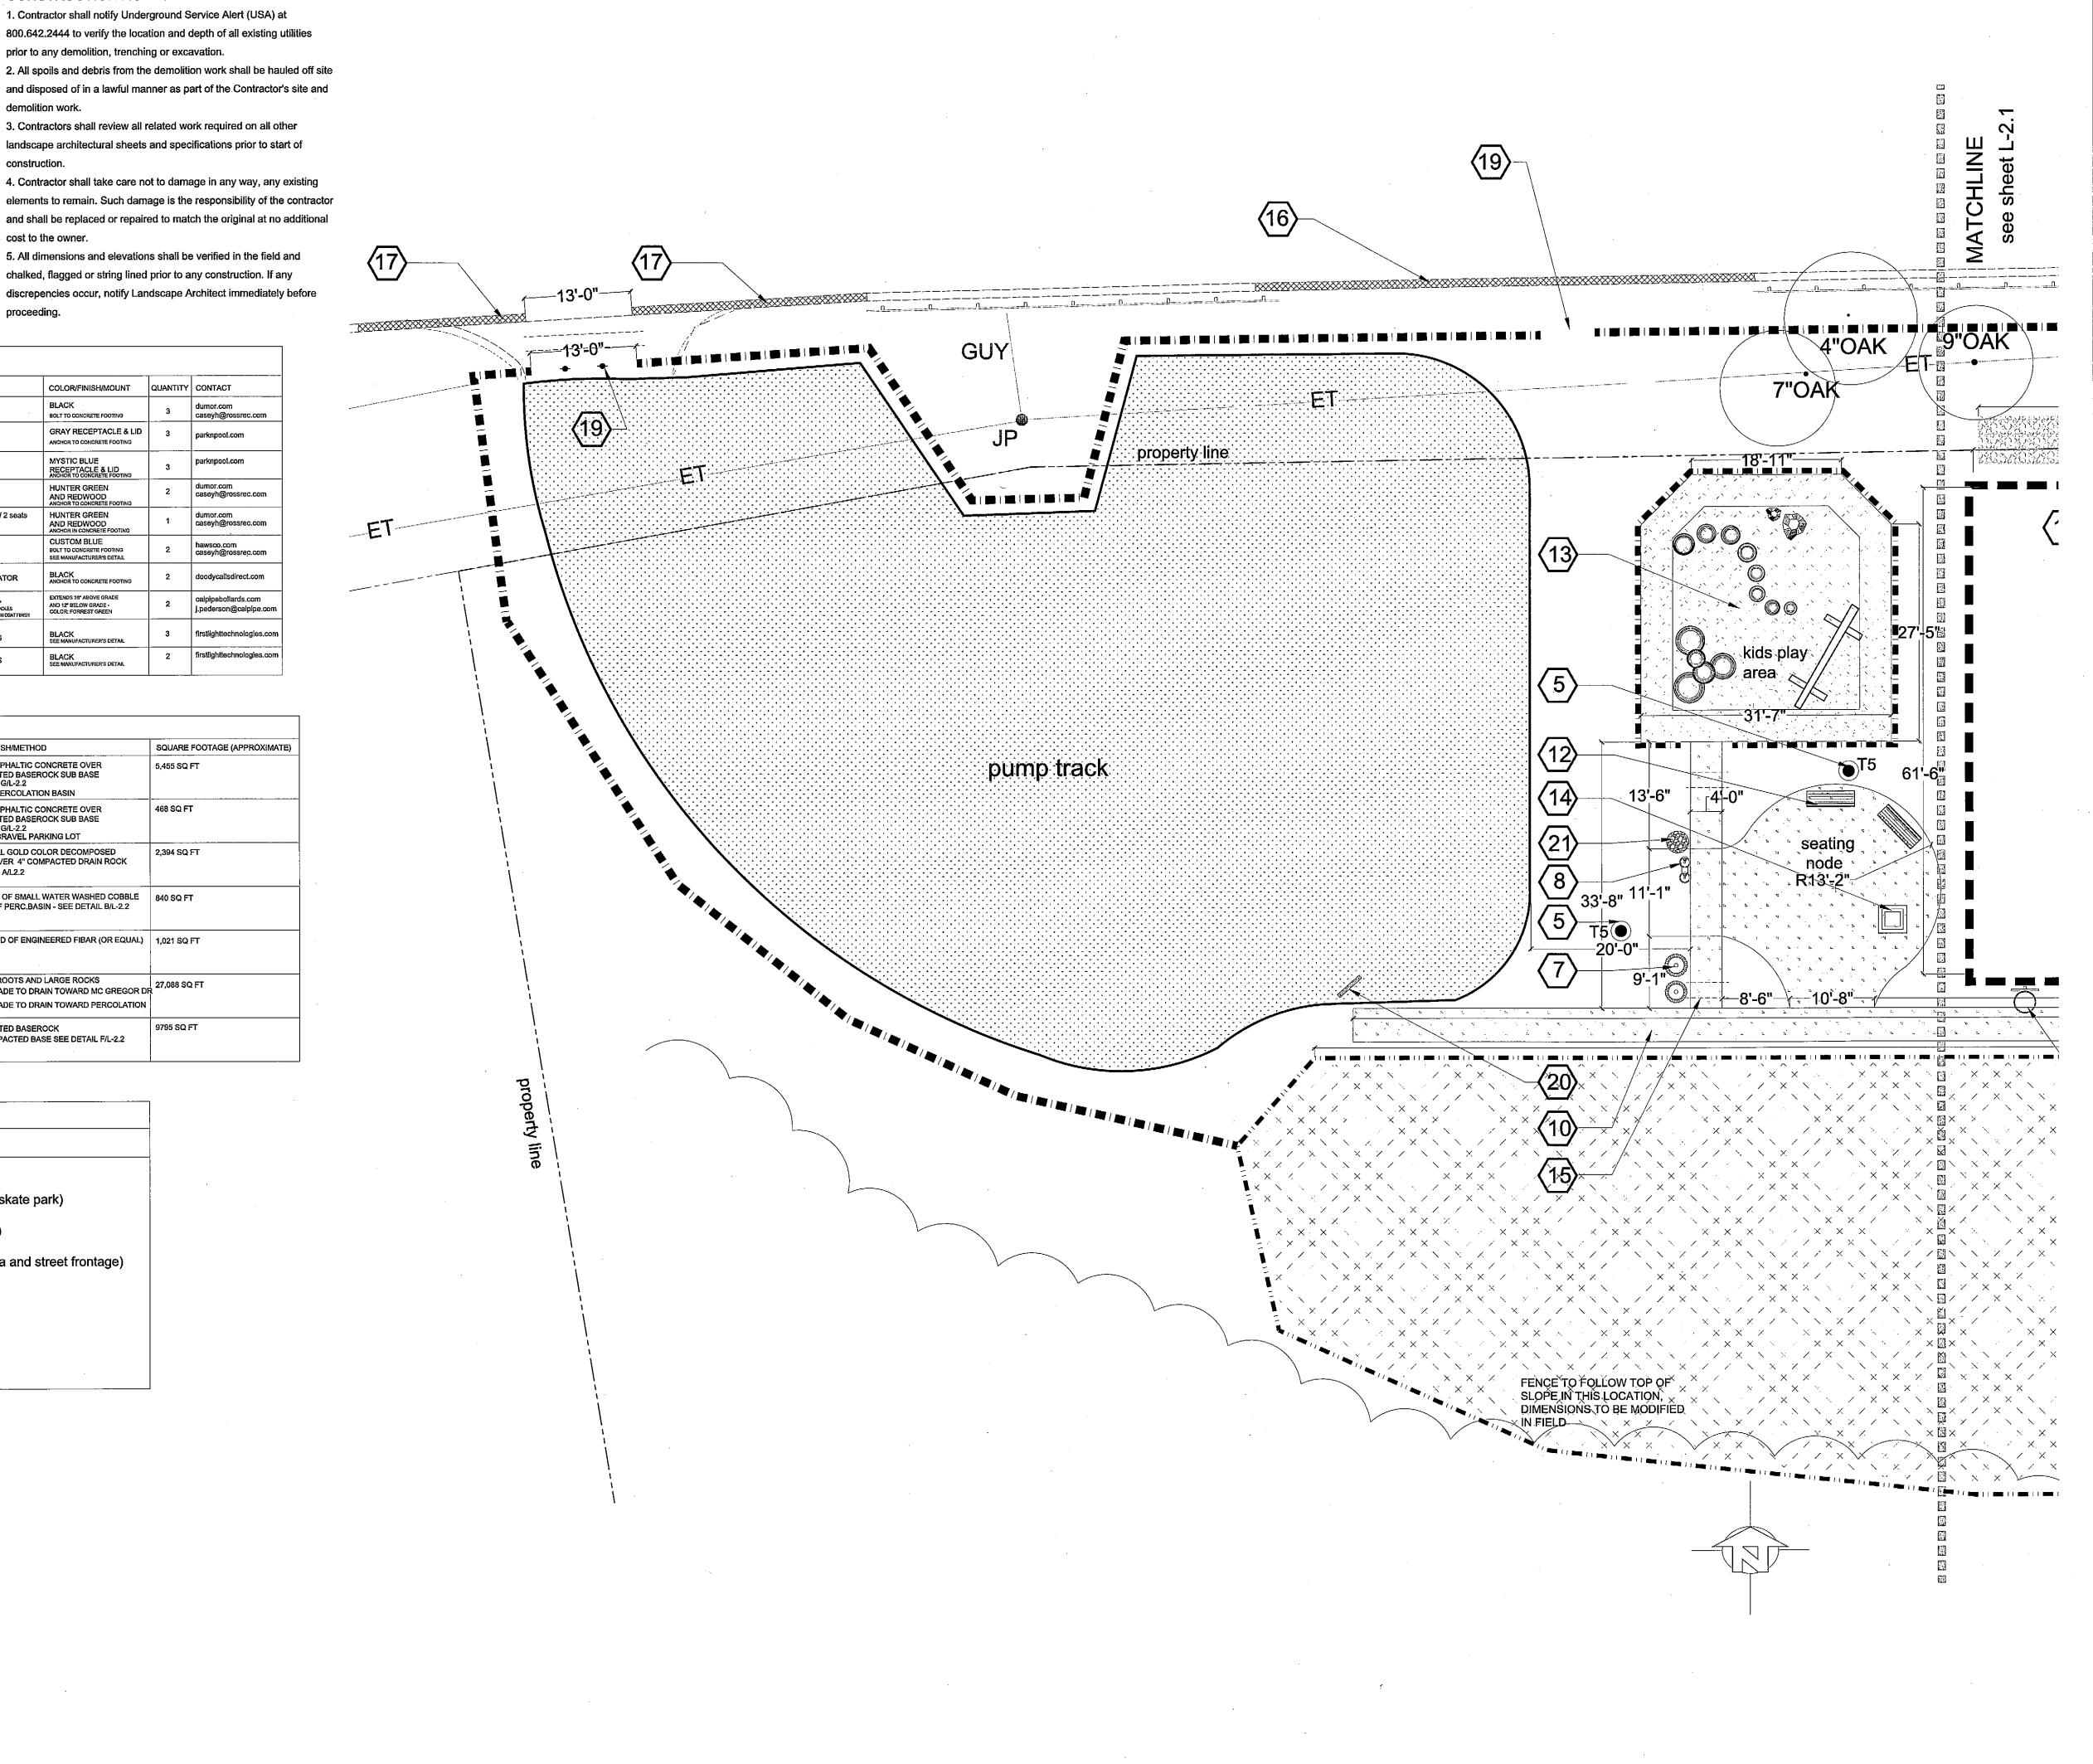
\* SEE PRODUCT CUT SHEETS ON L-2.3

KEY	DESCRIPTION	LOCATION	COLOR/FINISH/METHOD	SQUARE FOOTAGE (APPROXIMATE)
	ASPHALT	SKATE PARK	2" THICK ASPHALTIC CONCRETE OVER 6" COMPACTED BASEROCK SUB BASE SEE DETAIL G/L-2.2 SLOPE TO PERCOLATION BASIN	5,455 SQ FT
	ASPHALT	ADA PARKING	2" THICK ASPHALTIC CONCRETE OVER 6" COMPACTED BASEROCK SUB BASE SEE DETAIL G/L-2.2 SLOPE TO GRAVEL PARKING LOT	468 SQ FT
	DECOMPOSED GRANITE w/ STABILIZER	PATHWAYS AND SEATING AREA	2" THICK CAL GOLD COLOR DECOMPOSED GRANITE OVER 4" COMPACTED DRAIN ROCK SEE DETAIL A/L2.2	2,394 SQ FT
	COBBLE	TOP OF PERCOLATION BASIN	2" THICK BED OF SMALL WATER WASHED COBBLE OVER TOP OF PERC.BASIN - SEE DETAIL B/L-2.2	840 SQ FT
	BARK MULCH	KIDS PLAY AREA	8" THICK BED OF ENGINEERED FIBAR (OR EQUAL)	1,021 SQ FT
**************************************	BARE SOIL	DOG PARK PUMP TRACK PHASE I SKATE PARK	CLEAR OF ROOTS AND LARGE ROCKS ROUGH GRADE TO DRAIN TOWARD MC GREGOR DF ROUGH GRADE TO DRAIN TOWARD PERCOLATION BASIN	27,088 SQ FT
	GRAVEL	MAIN PARKING LOT	8" COMPACTED BASEROCK OVER COMPACTED BASE SEE DETAIL F/L-2.2	9795 SQ FT

LEGEND	•
KEY	DESCRIPTION
	ADA accessible walkway
	4' black vinyl clad chain link fence (skate park)
	42" wood and wire fence (dog park)
	3' high split rail fence (kids play area and street frontage)
$\overline{(\cdot)}$	Existing trees to remain
5"OAK	Existing trees to be removed
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Michael

MICHAEL A. ARNONE

No. 3347 (Exp 7/31/14)

4.16.14 bid set MA

West Layout

and Materials

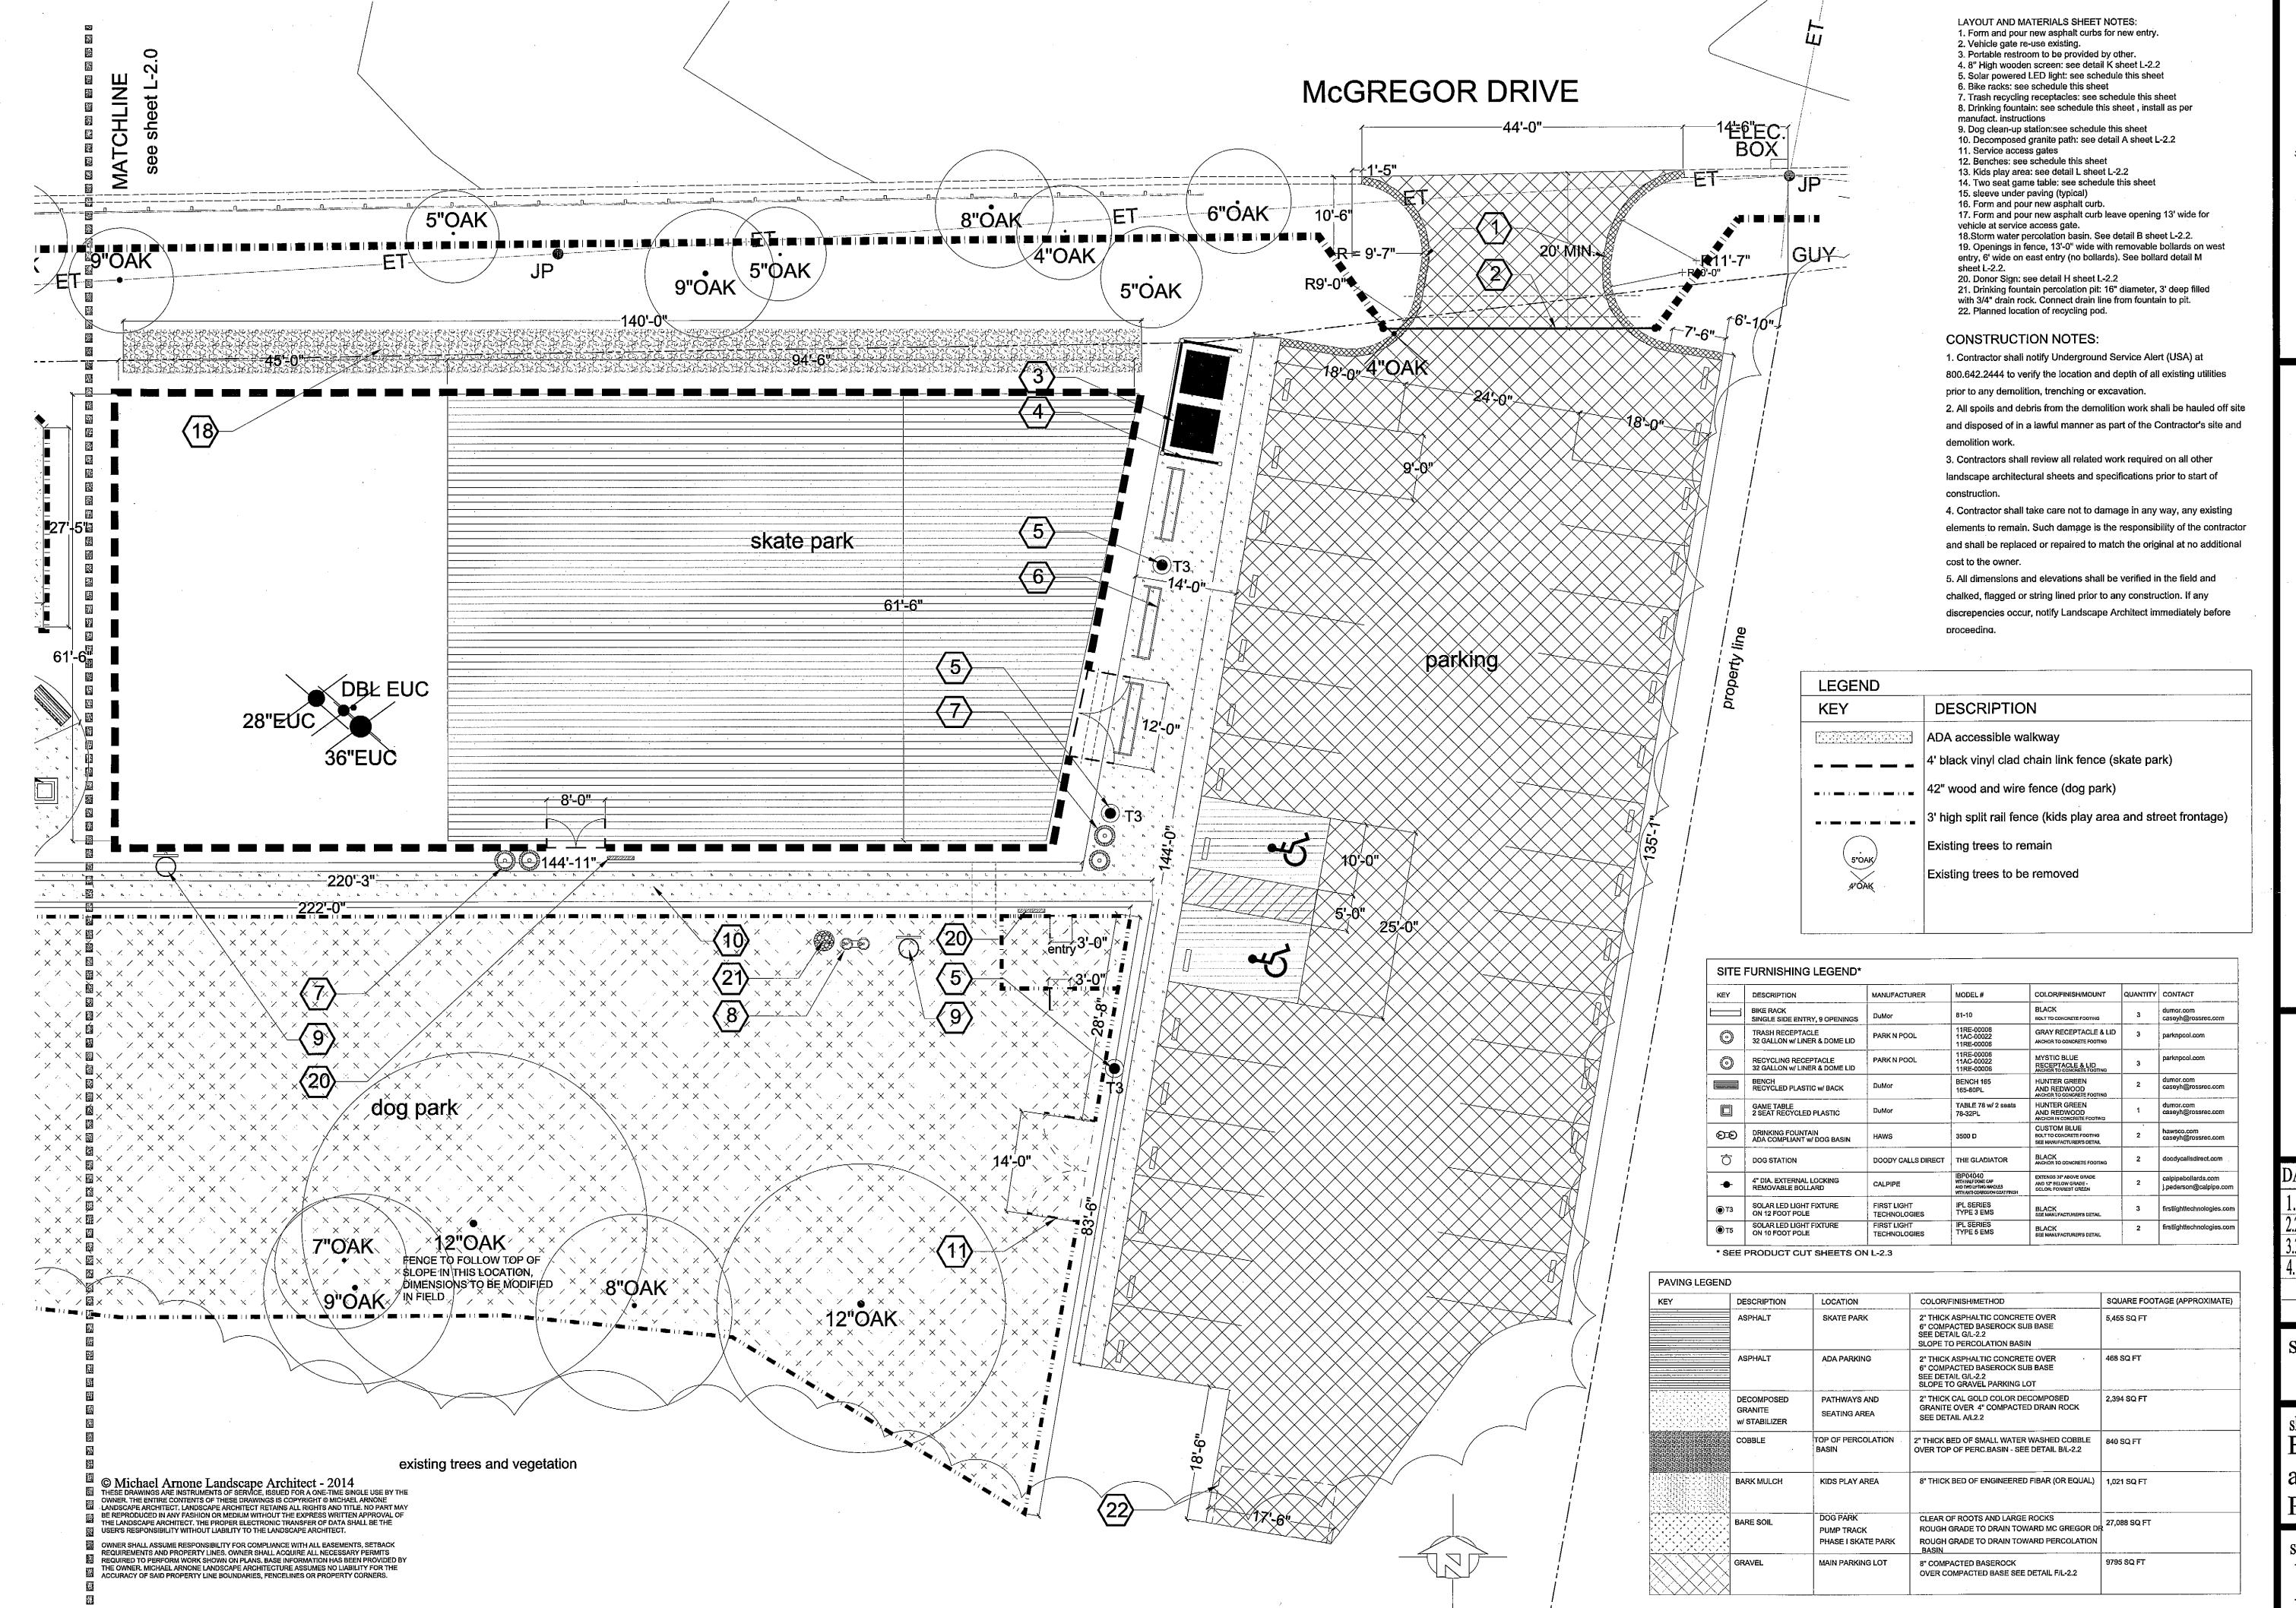
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Michael Arnone +

## MCGREGOR DRIVE, CAPITOLA

MICHAEL A.
ARNONE

No. 3347
(Exp 7/31/14)

OF CALIFORNIA

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6.14 planing commission submittal

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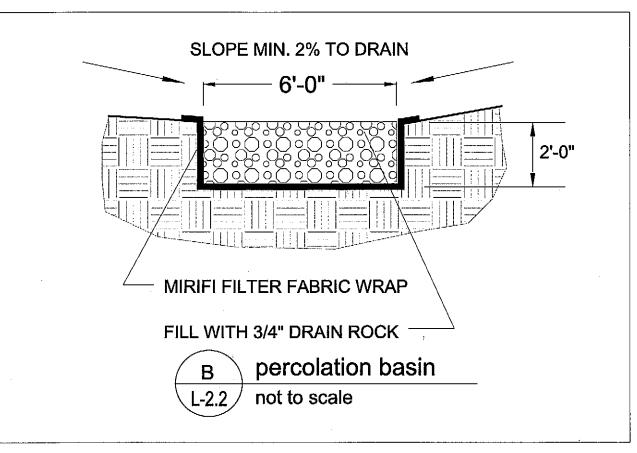
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East Layout

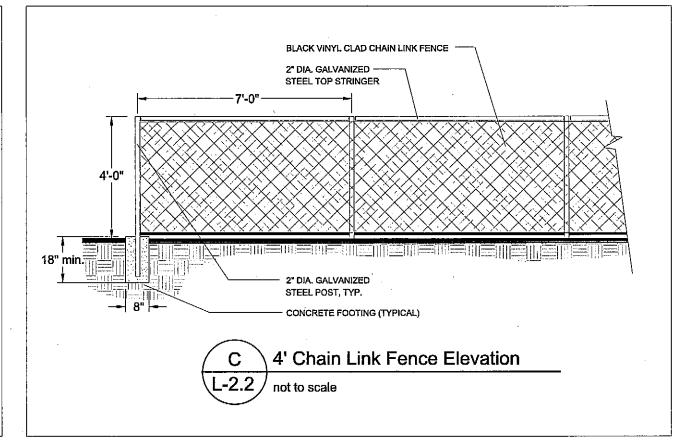
East Layout and Materials Plan

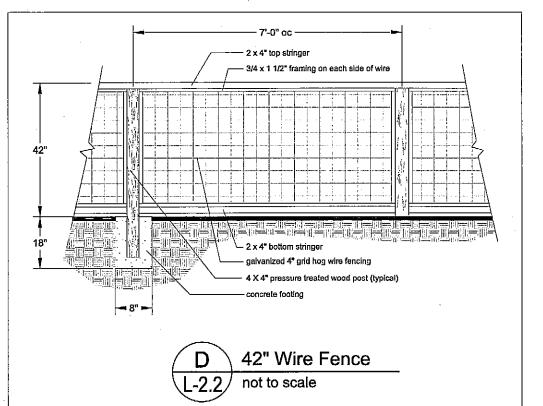
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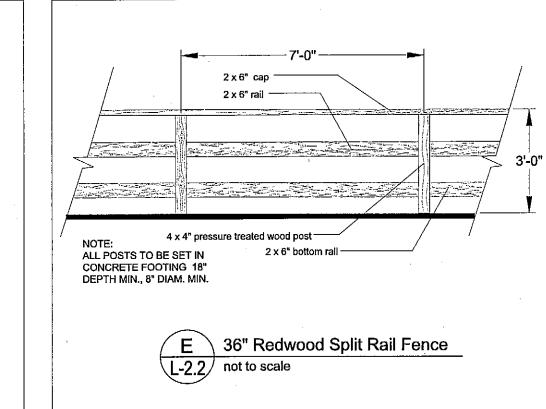
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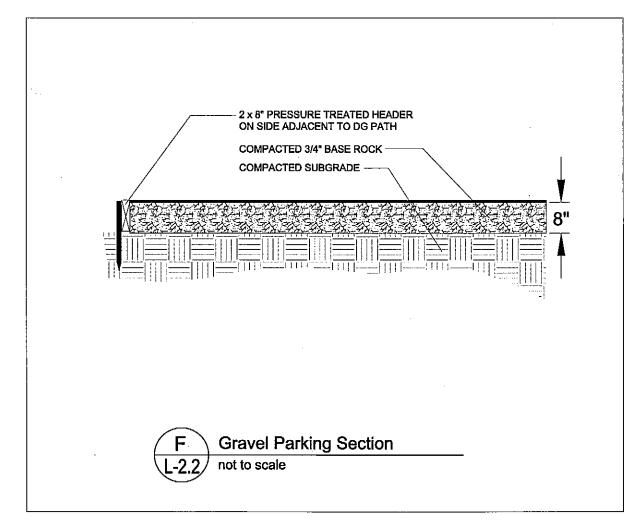
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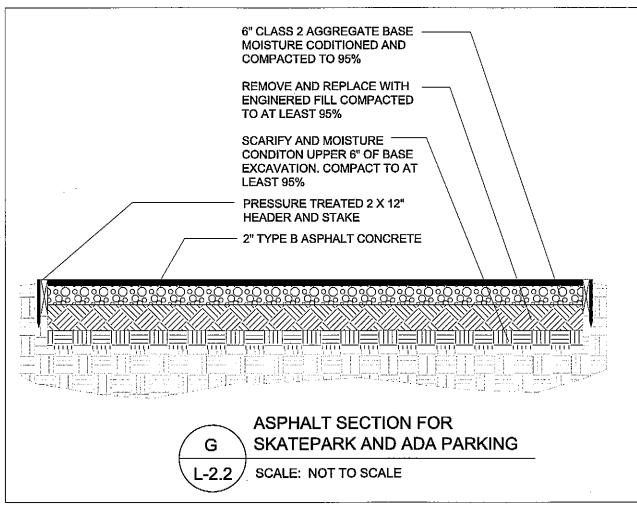


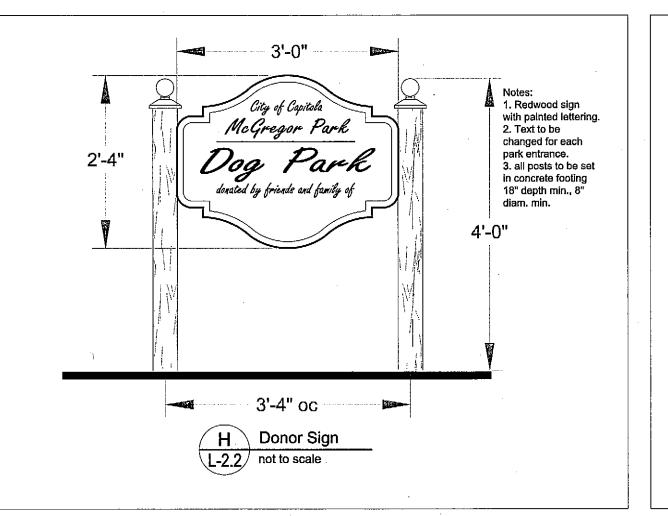


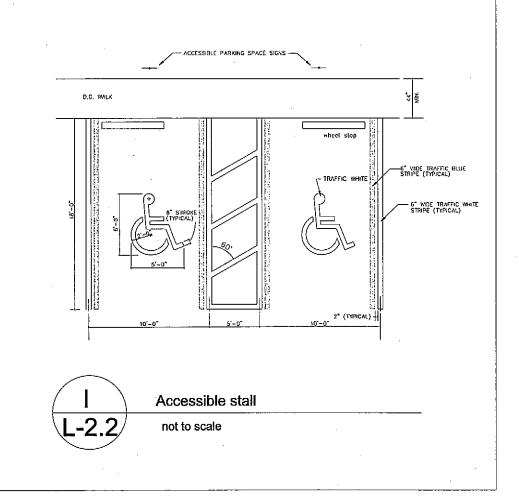


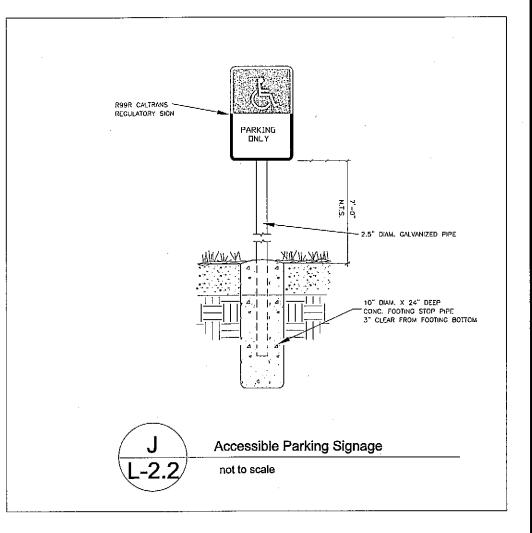


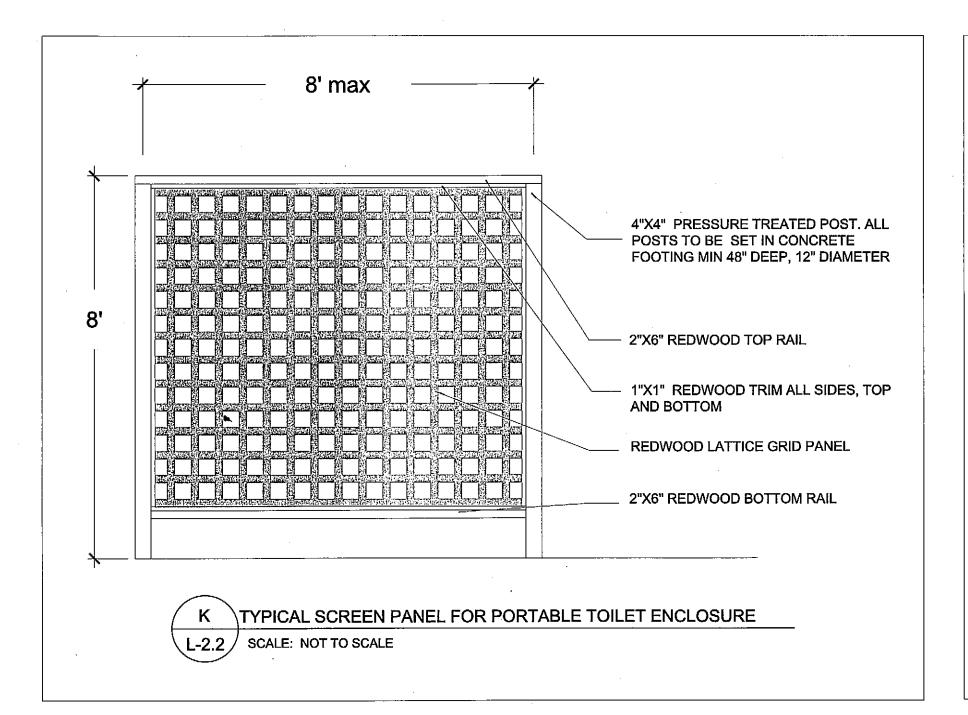


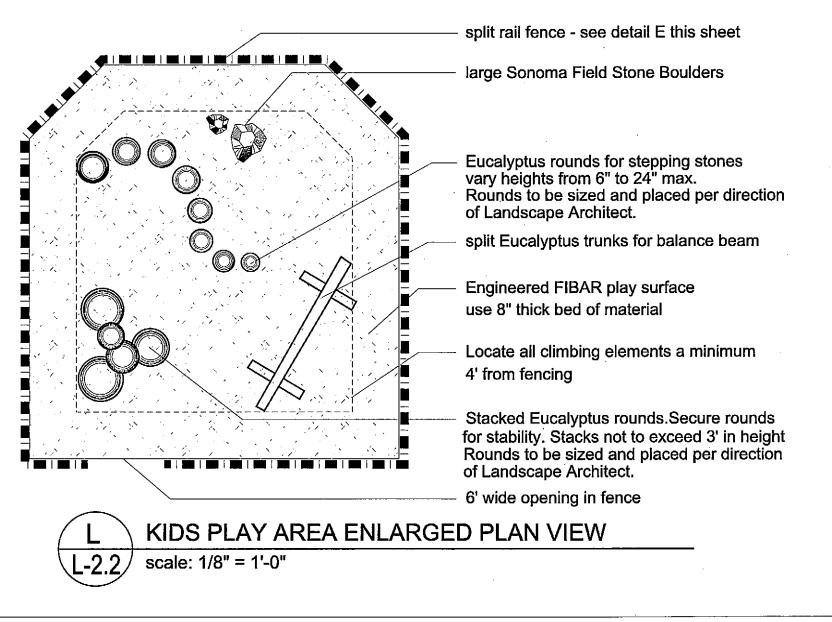


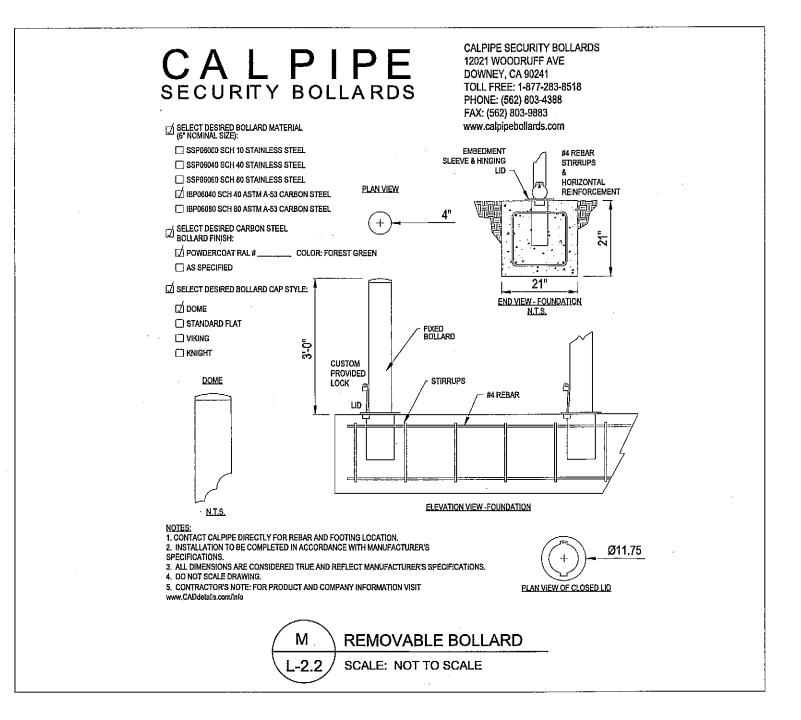








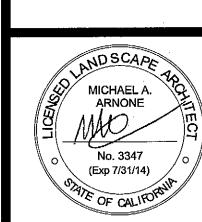




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Michael A



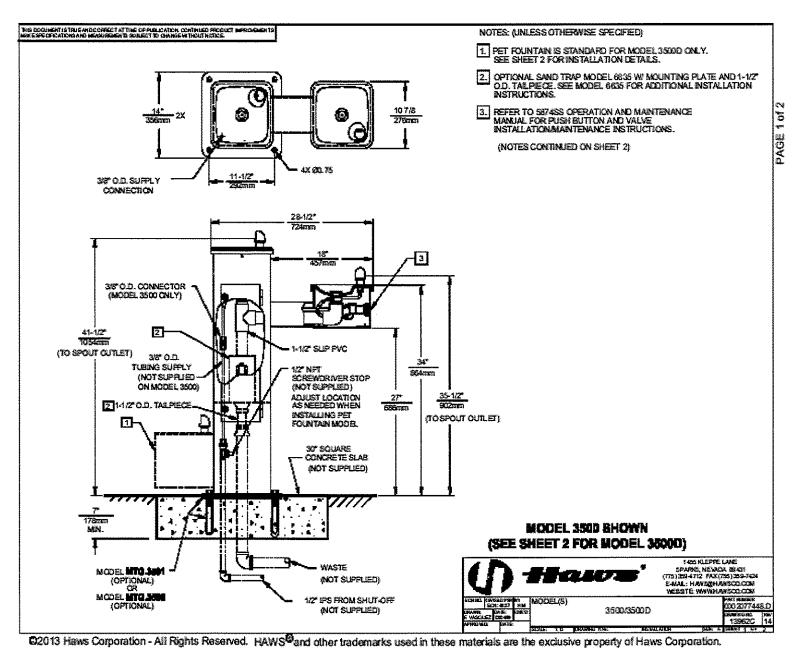
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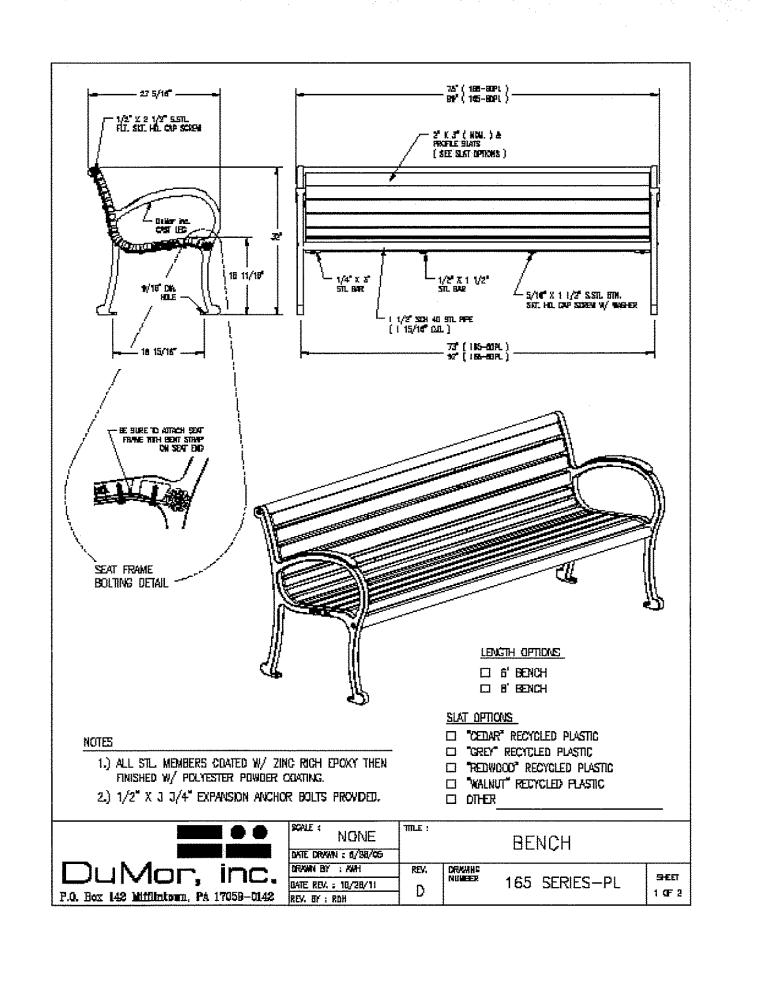
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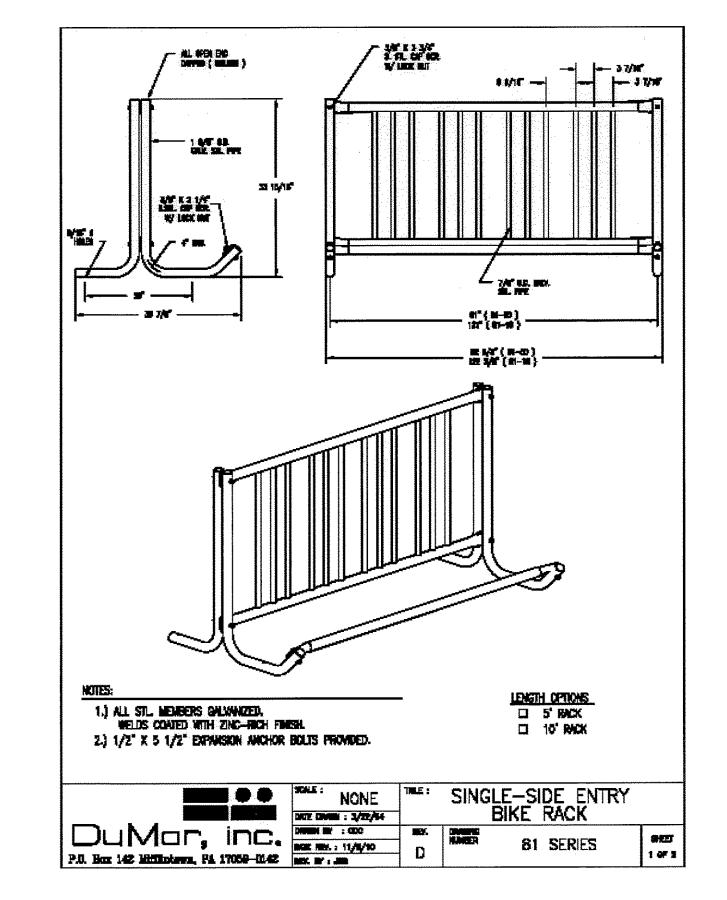
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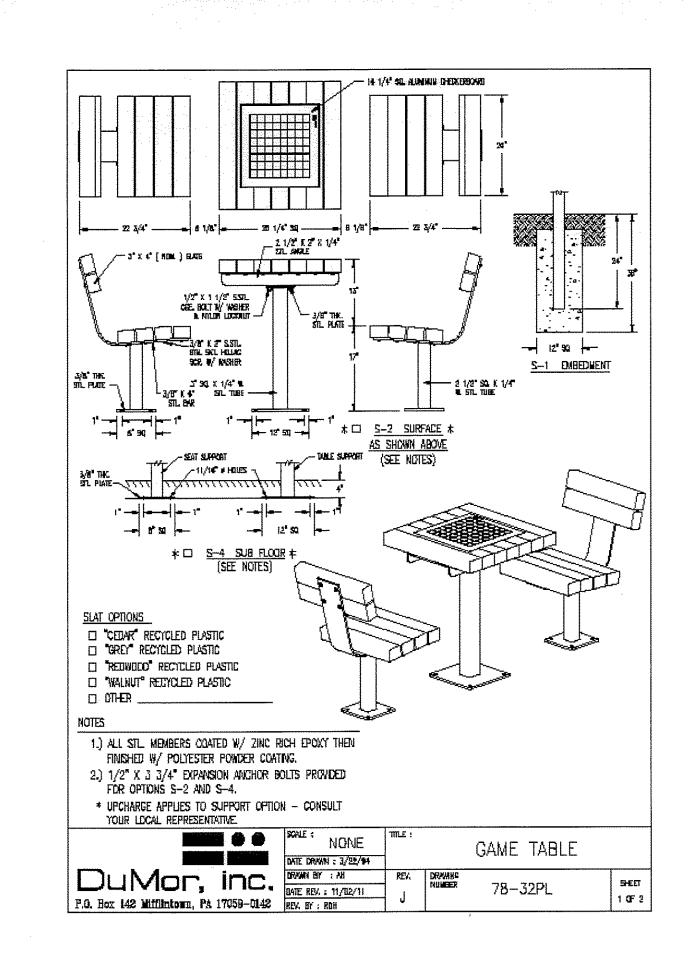
sheet title: Layout and Materials Details

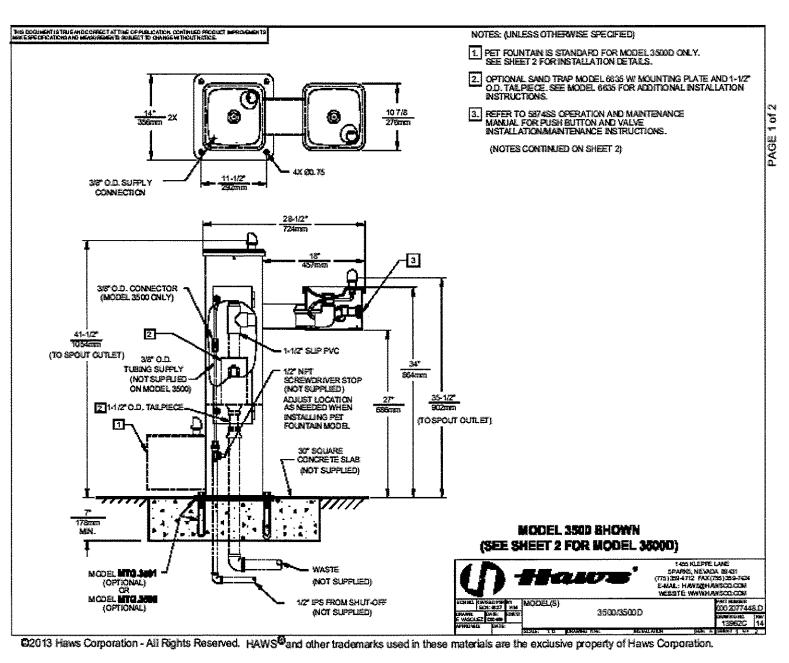
Trash and recycling receptacle by Park n Pool gray color for trash/mystic blue color for recycling

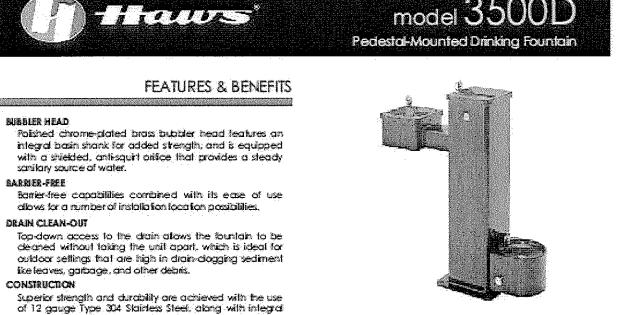












3/8" [.95 cm] thick cost stainless bows. The unit is himmed

with a glossy green powder-coal firsh and it is secured to

front access steam adjustment as well as cartidate and

strainer access, this fountain afters 100% lead free

☐ Sand Trap: Model &&11, sand trap for installing adjacent to

☐ Sand Trap: Model 6635, in-pedestal sand trap for models

☐ Mounting: Model MTG.3500 mounting plate gives in-ground

To see at options for this model, visit www.hawsco.com

Mounting: Model MTG3501, galvarized steel anchors.

support for the 3500 series pedestal fountains and includes

contaminants from clogging was le line.

pedestal drinking fountains to help prevent debris and

waterways. The valve works at an operating pressure range

the ground with an integral mounting plate. Ease of maintenance is achieved with the use of an Model 35000 "Hi-Lo" barrier-free, superior-duty vandal resistant extra-large access door supplied with heavy-duty door pedestal drinking fountain with attached pet fountain shall hinges, and is locked by square key pins. include a 12 gauge Type 304 Stainless Steel pedestal with integral 3/8" (95 cm) thick cost stainless steel busins, all with green powder-coaling, push-button operated stainless steel Unique design allows for conine access so pel and owner valves with front-accessible cartridge and flow adjustment. 100% lead fee waterways, polished disonne plated brasvanda-resistant businer heads, polished disome-plated With its patented (Fat. # 4981,492) staintess steet brass vandakresistant waste strainers with too-down dean-out access, pet basin with modified waste strainer to push-button activated valve assembly which allows for accommodate a puddle effect large access door with

**APPLICATIONS** 

**SPECIFICATIONS** 

Taking performance and protection to a whole new level is his superior duty drinking foundain. This unique drinking foundain is the perfect addition to parks, rest areas, and correctional facilities where vandaism may be more prone to take place. By welding the bowls directly to the uprights, they became one with the unit, preventing removal. That, in addition to many other features for vandal-resistance, makes his foundain virtually indestructible. This series foundain may also be applicable in a wide assortment of other places. specifically dog parts due to the ground level animal

heavy-duty hinges and square key locks, vandal-resistant

bottom plate, integral mounting plate, and 1-1/2" Sp waste.

Model meets at current Federal Regulations for the disabled including those in the Americans with Disabilities Act. Hows® manufactures divising foundairs and electric water codes to be lead-free by all known definitions including NSF/ANSI Standard 61, Section 9, NSF/ANSI 372, California Proposition 65, and the Federal Sale Disting Water Act. Product is compliant to California Health and Safety Code 116875 (A8

3500 and 3511.

the mounting hardware.

ACCESSIBILITY

PET ACCESS

PUSH BUTTON

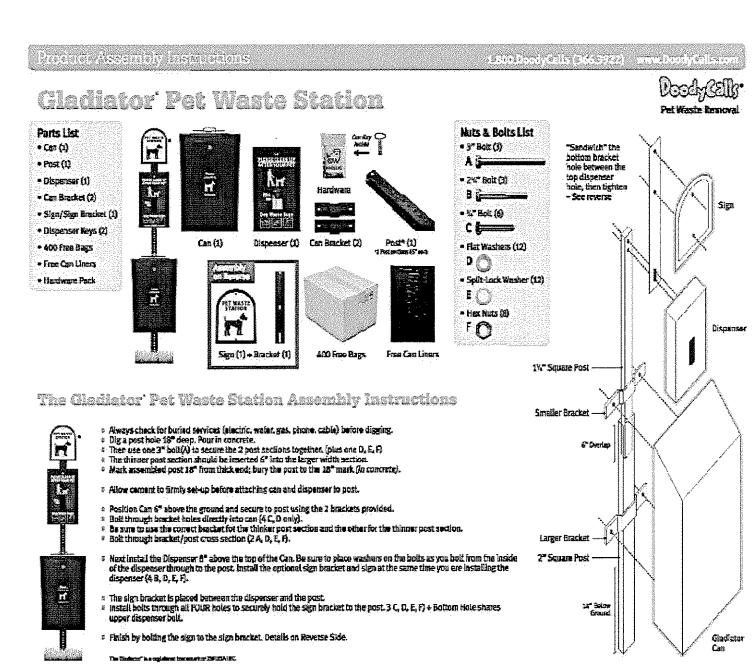
can quench their thirst in one place.

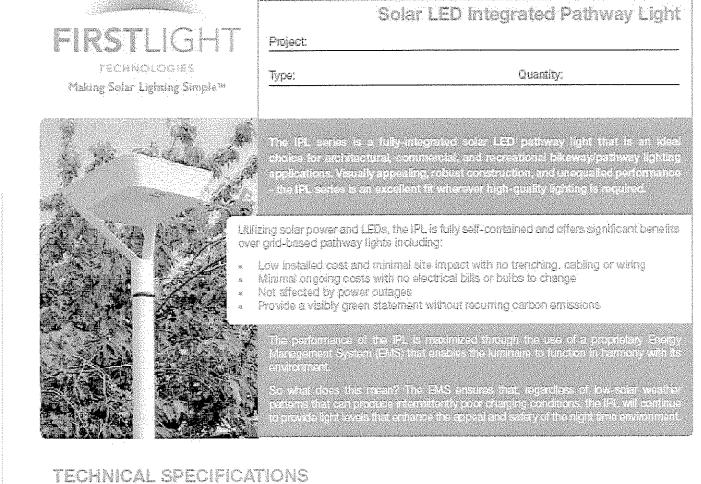
of 30 to 90 psi [2.1 to 4.2 bor].

t 455 Klappe Lore - Sports, NV (9 43) p.p. 775 357 47 (2 pl. 775 357 7 43) per infollores accommens www.howscocomm20 December 20 3 revenues make apschiodiora subject to change without radios. Chick www.howsco.com/or (tel lore) product information and updates.

occessibily.

OPTIONS





## LEDs and • 100,000 hour L70 lifetime High-efficiency resoc-crystalline cells. Inconspict your year that on top of luminates Warm (3000H) and neutral (4300H) color Used for day/right detection (no photocal) required) temperatures ovailable High efficiency Type 2, 3, and 5, full out-off optics High-efficiency temperature compensated Maximum Typical lumen output from 700 to 1200 lumens. Power Point Tracking (MPPT) Micro-controller based technology Mechanical - Cast, low supper aluminum top, trocking, and arms Inckdes high-eificiency LED driver Construction: « Stainless lasteners with security festaner option Architectural grade, super durable, TGIC powder cost Integrated into luminate bousing with Alodine undercoat Designed to automatically manage lighting Four standard colors with custom colors available performence beset on anvironmental conditions and lighting requirements Petent Peoding

Sealed lead acid, absorbed glass mat (AGM)

Designed for easy bottery charges when required

Superior cyclic performance

Contained within functions bousing

High temperature telerance

10 year design lite

Factory Set • On at duels, off at dawn On at dusk, off after 6 hours On at dusk, dim to 30% after 6 beens till dawn On si dusk, off after 5 hours, on 1 hour before dawn On at dusk, dim to 30% sales 5 hours, on 1 hour

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Michael A

MICHAEL A. ARNONE No. 3347 (Exp 7/31/14) THE OF CALIFORN DATE PURPOSE

1.6.14 planning commission submittal MAA 3.31.14 bid set MAA 4.16.14 **bid** set MAA

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Site Furnishings and Lighting Cut Sheets

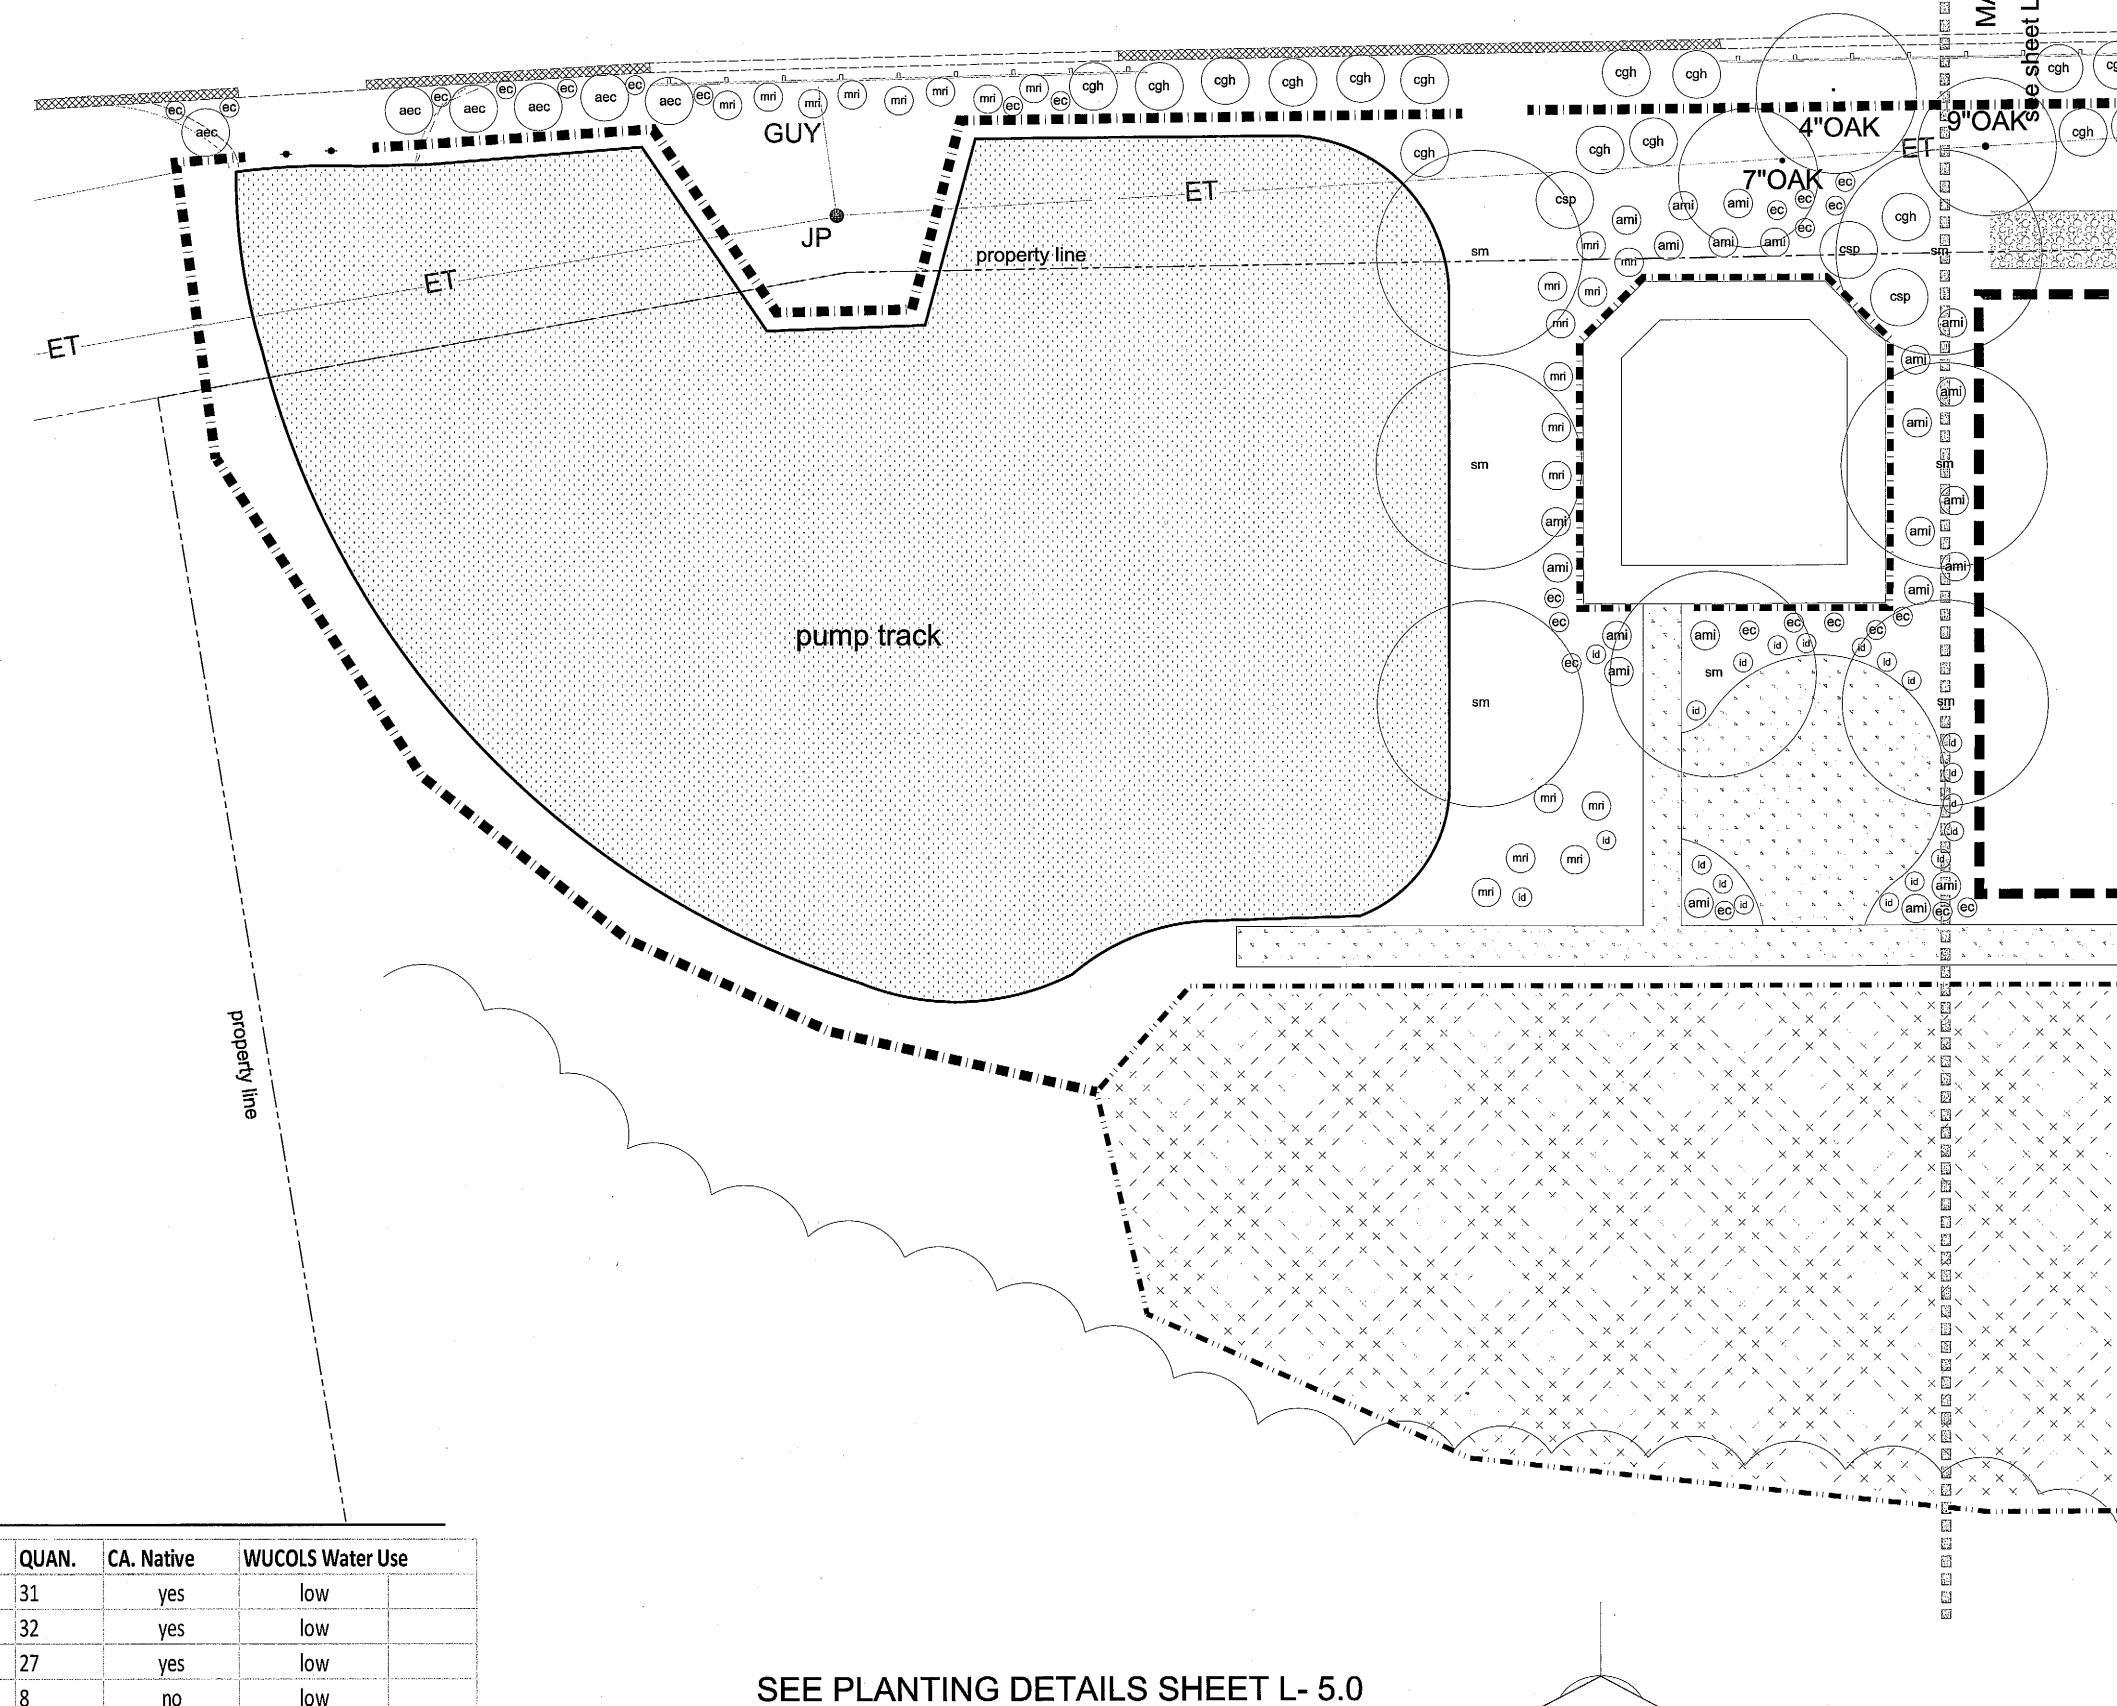
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of fourteen

## Planting Notes

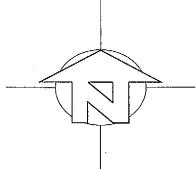
- 1. All existing trees, shrubs and ground covers to remain shall be protected. Any damage caused by Contractor's work shall be repaired or replaced at the Contractor's expense and be approved by the Landscape Architect.
- 2. All planting areas shall receive 50 lbs "Sustane 5-2-4 + Fe" (or equal organic slow release fertilizer) soil fertilizer per 2500 square feet to be thoroughly incorporated into the top 6 inches of soil.
- Call Sustane Natural Fertilizer of America, Inc. 1-800-325-9245 for Distribution/Product Information. Or visit www.sustane.com
- 3. After amending soil, grade all areas smooth with no localized depressions exceeding .5 inch. All areas shall surface drain with 1.5 percent minimum slope away from all buildings, paving or other structures.
- 4. Quantities are for aiding in bidding only. Contractor shall verify all quantities. 5. Contractor shall lay out plant material as per plan and receive approval from Landscape Architect prior to installation.
- 6. No plants shall be planted with root balls or new pits in a dry condition.
- 7. Plant all plants as per planting details in square pits with sides and bottoms thoroughly scarified. Do not amend backfill mix beyond initial topsoil amending unless noted.
- 8. All newly planted material shall be watered by deep soaking within 3 hours of planting.
- 9. All planting areas shall receive 3 inches of mini- bark top dressing (mulch). 10. Contractor shall be responsible for irrigating all new plant material until the entire
- project as been approved and accepted by Owner.

11. Thirty days after planting Contractor shall restake and straighten all trees as necessary to be approved by Landscape Architect.



## PLANT LIST

KEY	BOTANICAL NAME	<b>COMMON NAME</b>	SIZE	QUAN.	CA. Native	WUCOLS Water Use
aec	Arctostaphylos 'Emerald Carpet'	Groundcover Manzanita	5 gal	31	yes	low
ami	Achillea millefolium	Yarrow	1 gal	32	yes	low
cgh	Ceanothus griseus horizontalis 'Yankee Point'	Carmel Creeper	5 gal	27	yes	low
csp	Cistus salviifolius 'Prostratus'	Rockrose groundcover	5 gal	8	no	low
ес	Eschscholzia californica	California Poppy	1 gal	55	yes	low
id	Iris douglasiana	Pacific Coast Iris	1 gal	20	yes	low
sm	Schinus molle	California Pepper	24" box	7	yes	low
mri	Muhlenbergia rigens	Deer Grass	1 gal	83	yes	low



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# MICHAEL A. ARNONE

(Exp 7/31/14)

1.6.14 planing commission submittal
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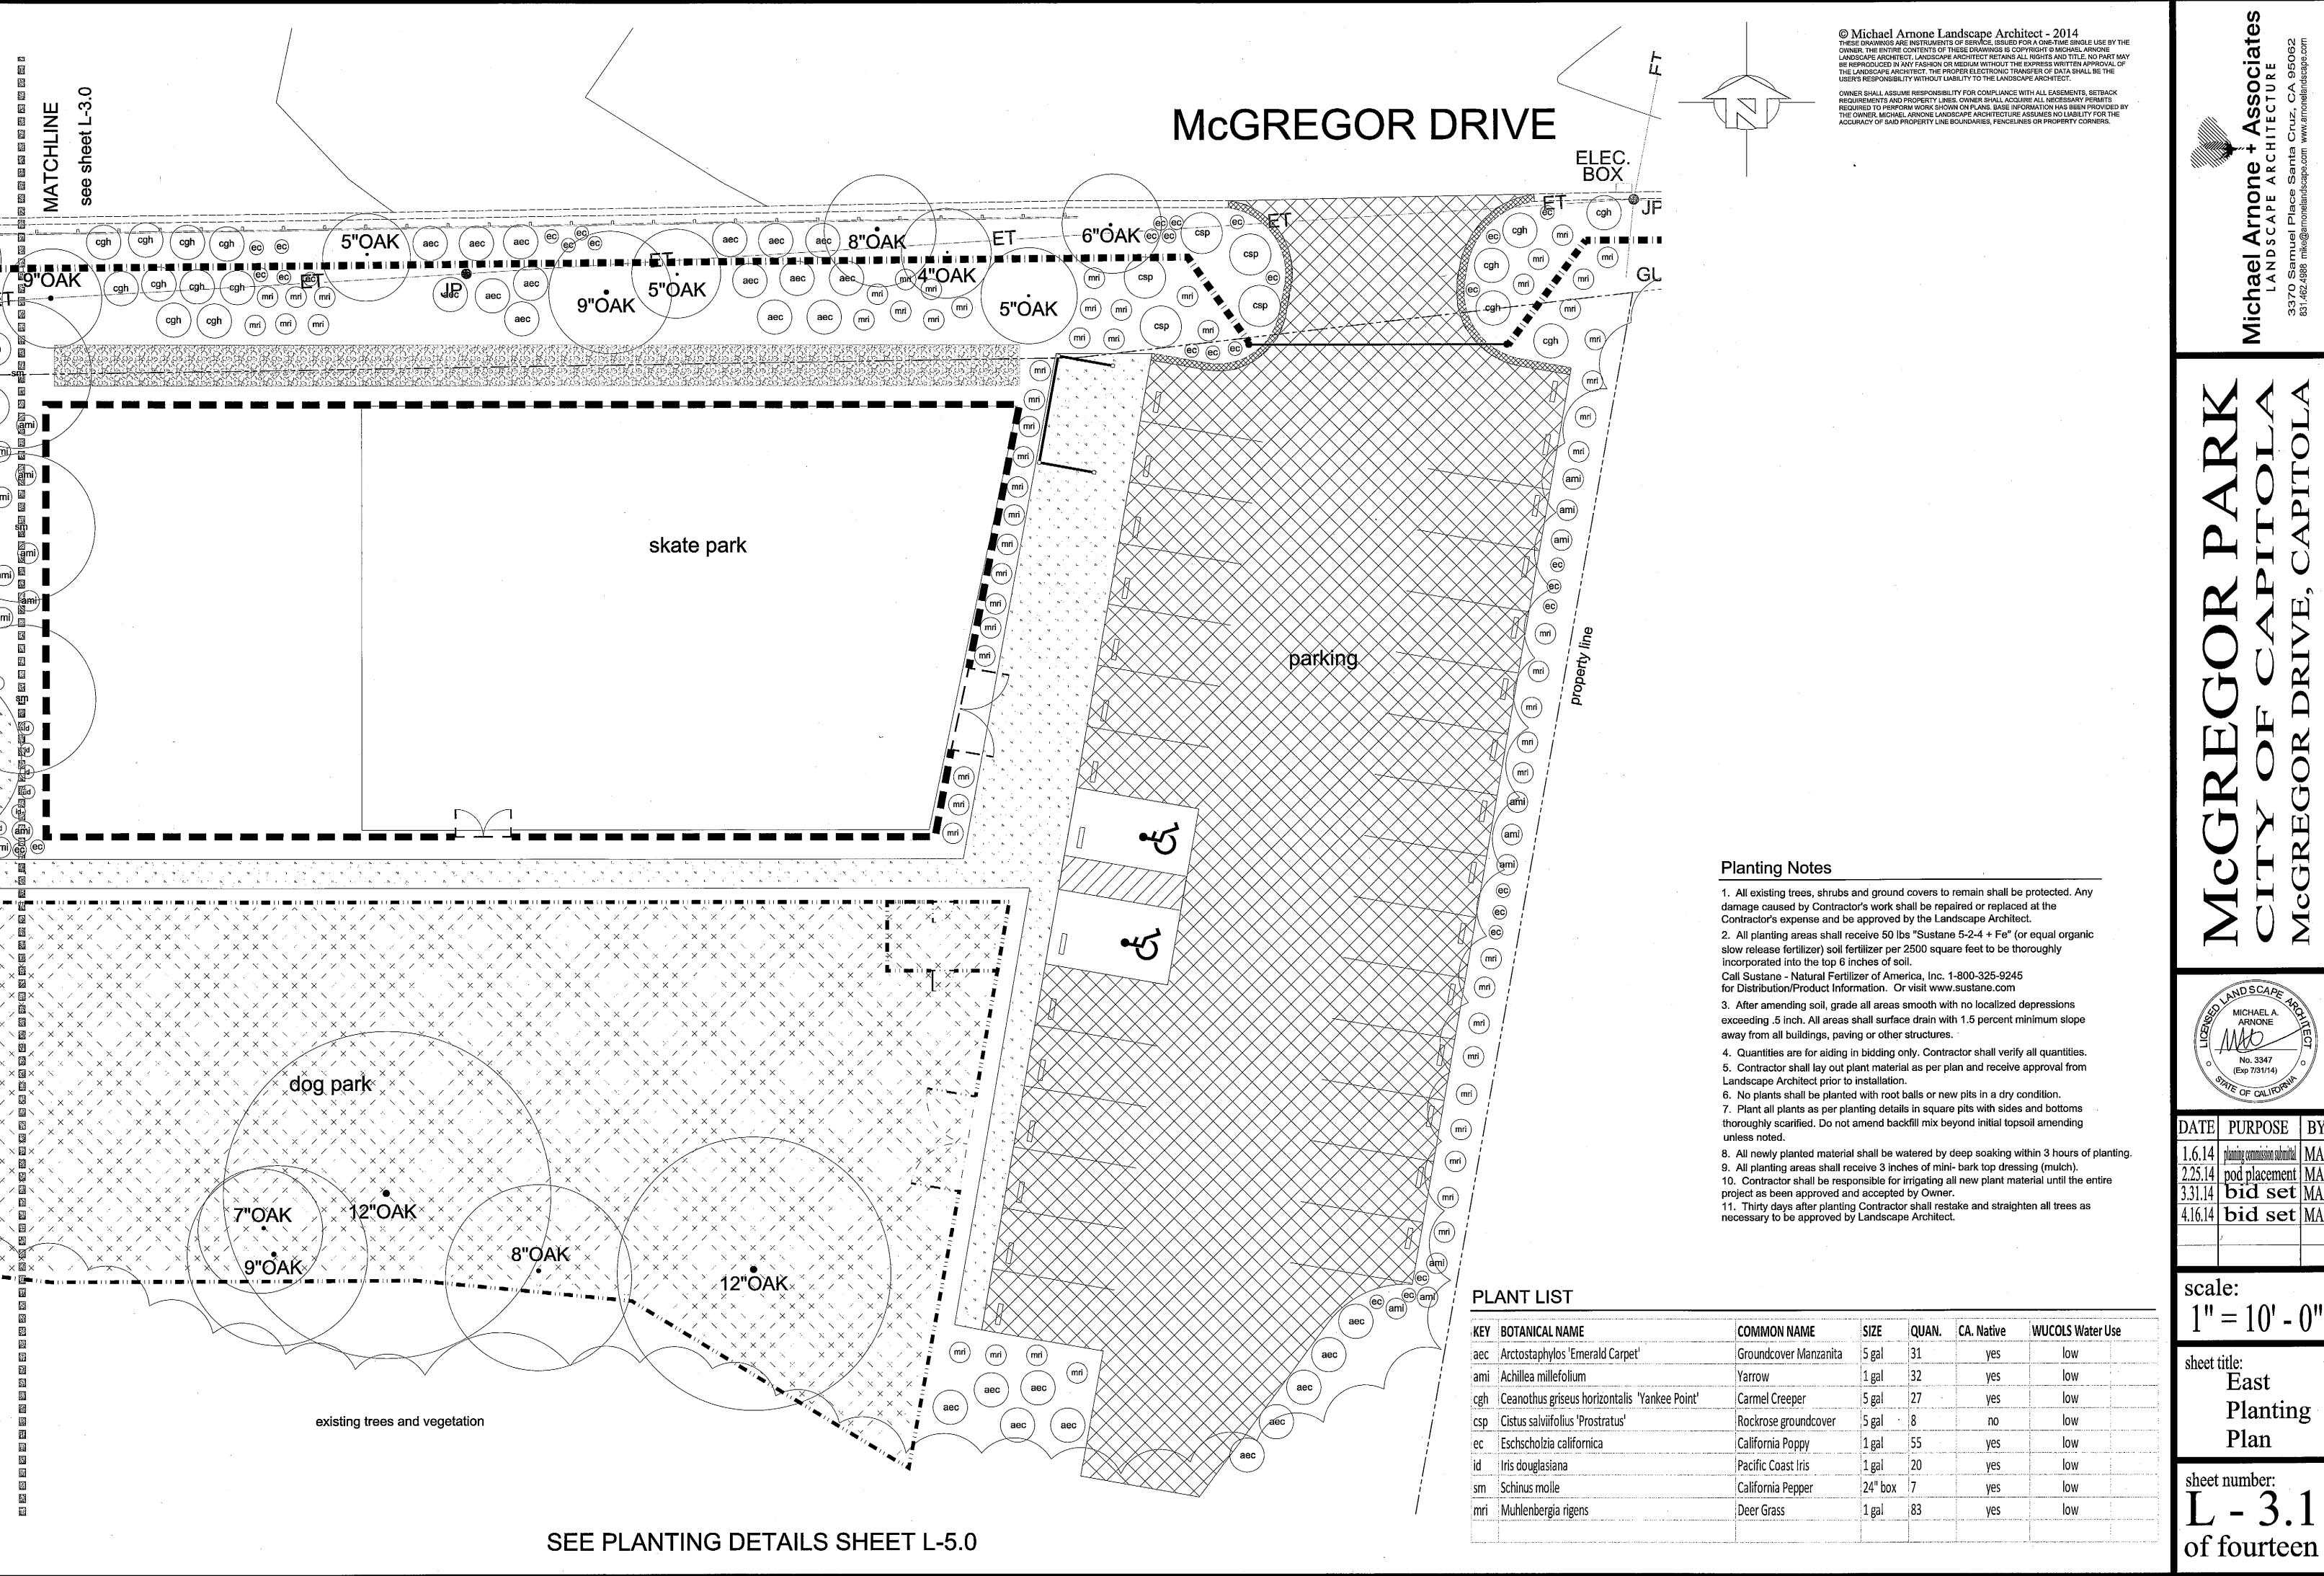
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of fourteen

West

Planting

Michael A



(Exp 7/31/14)

pod placement MAA

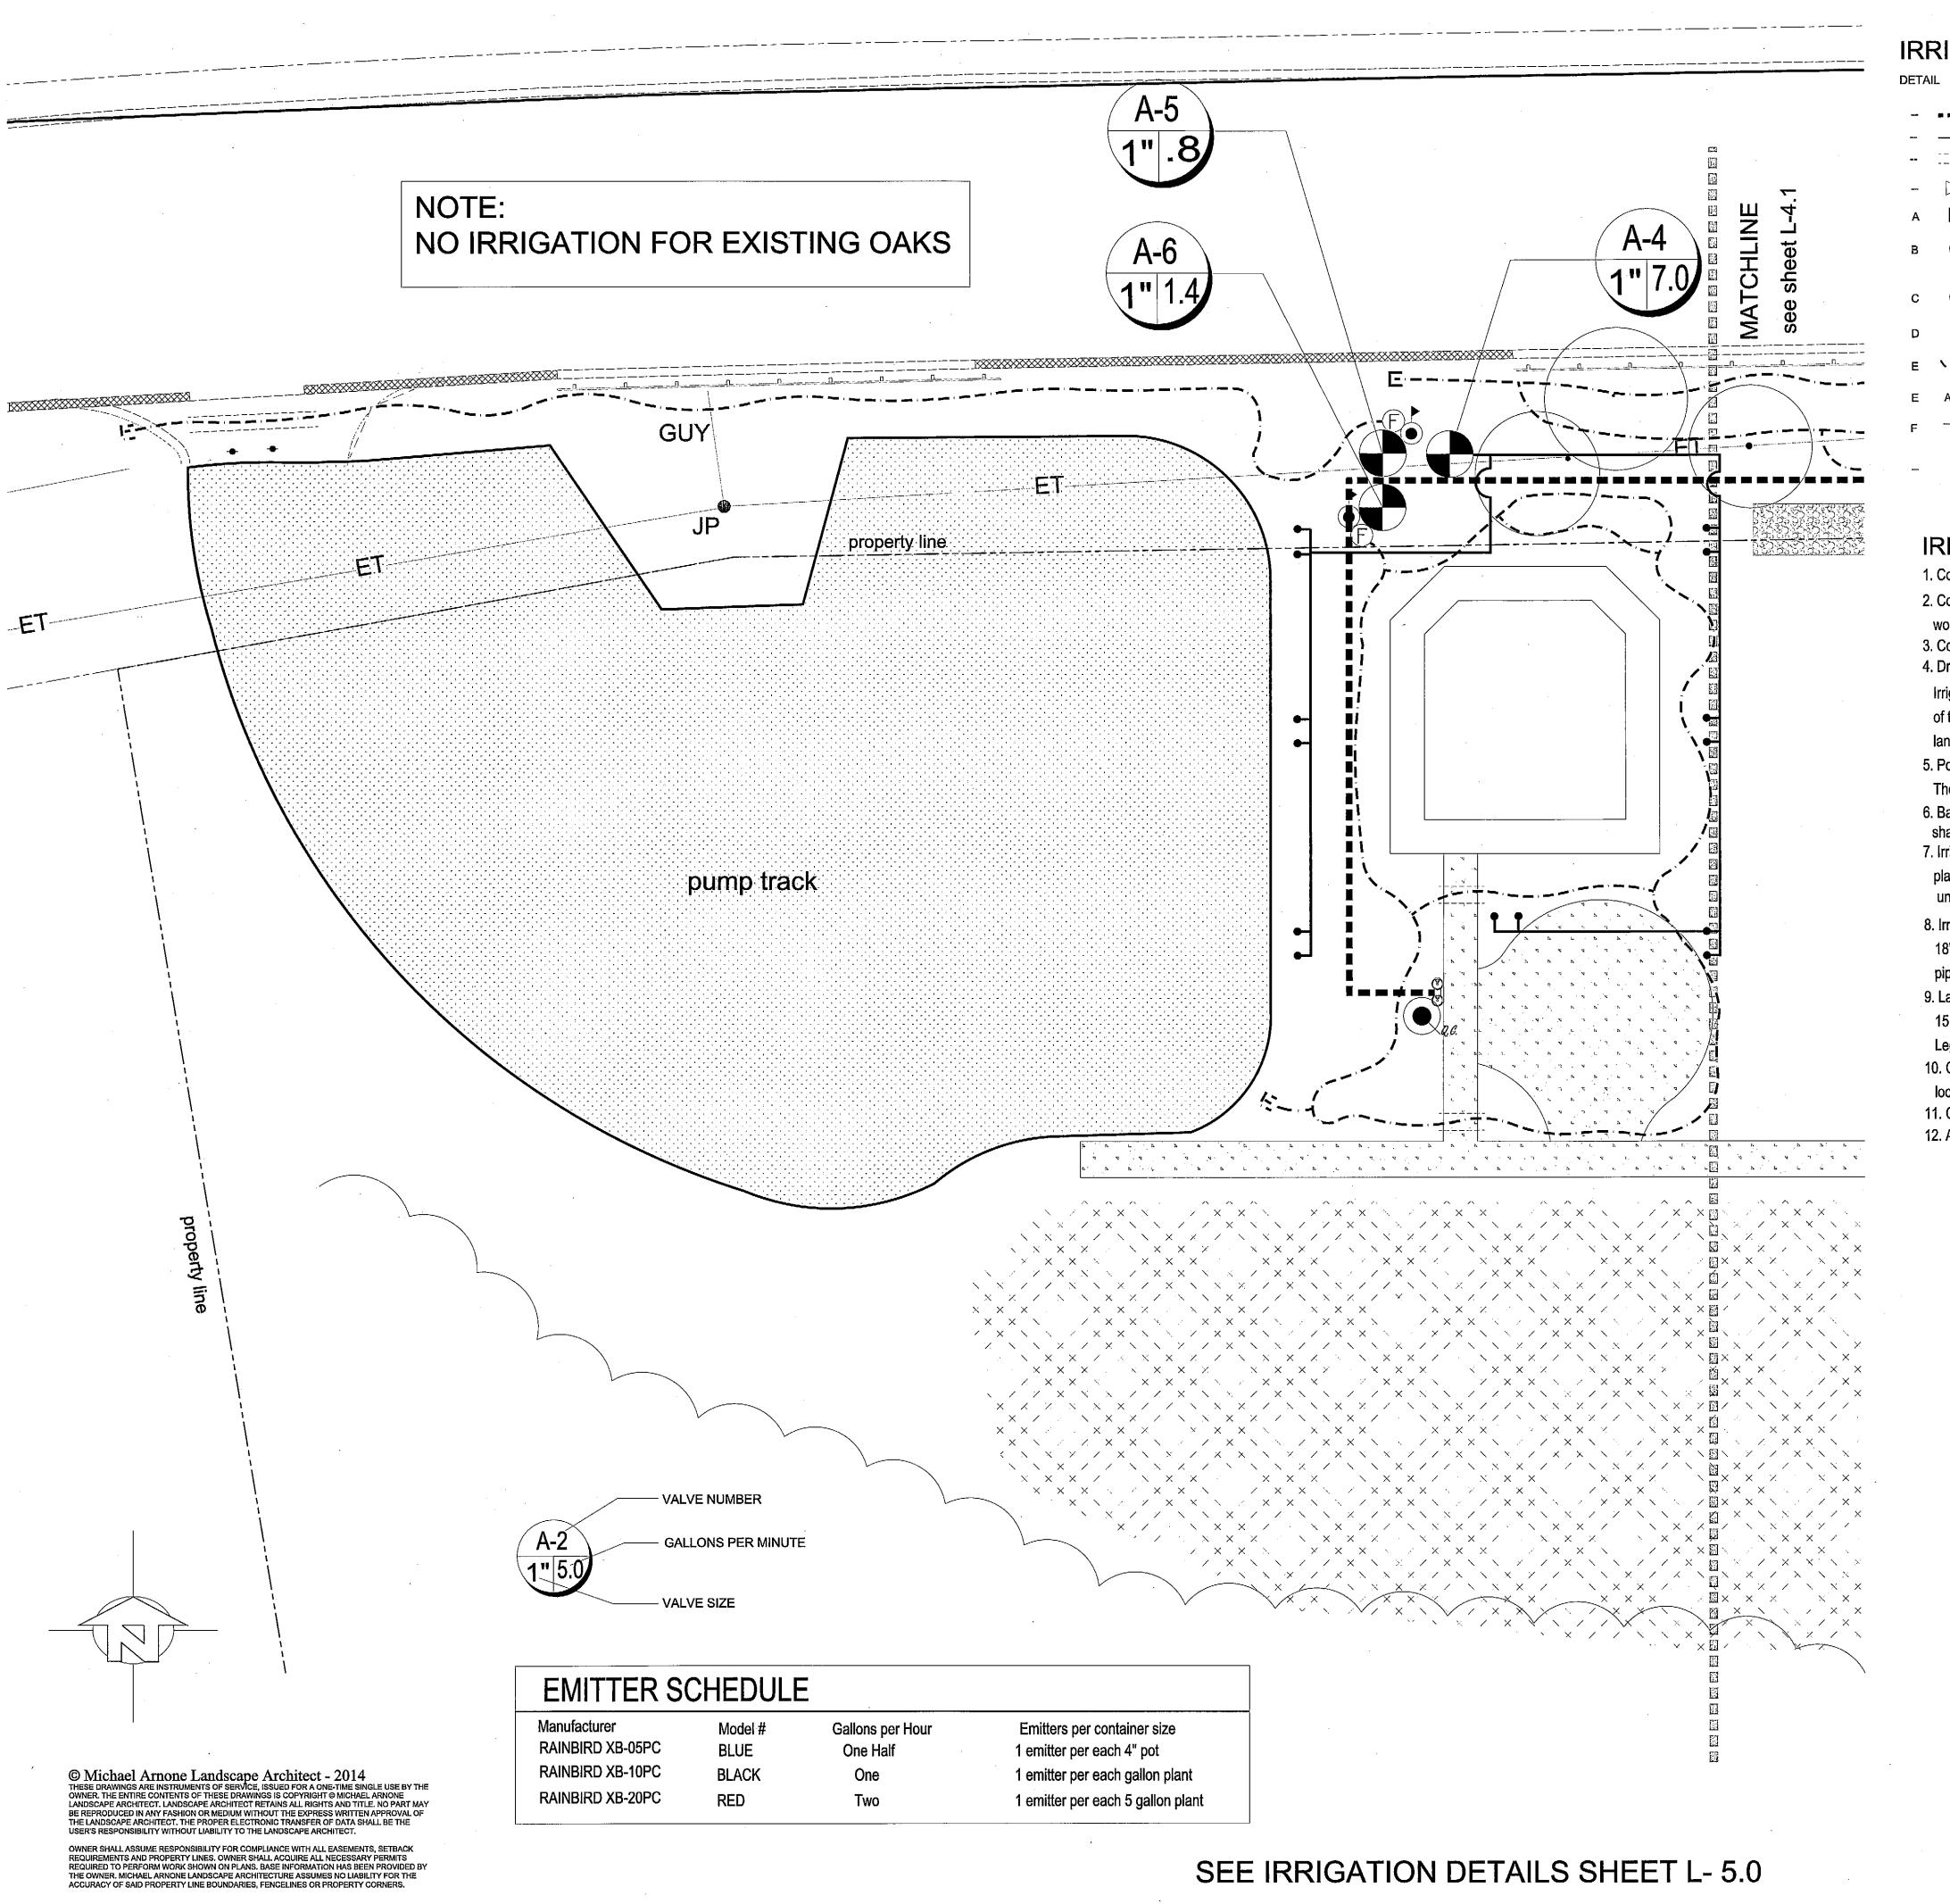
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East Planting

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## IRRIGATION LEGEND

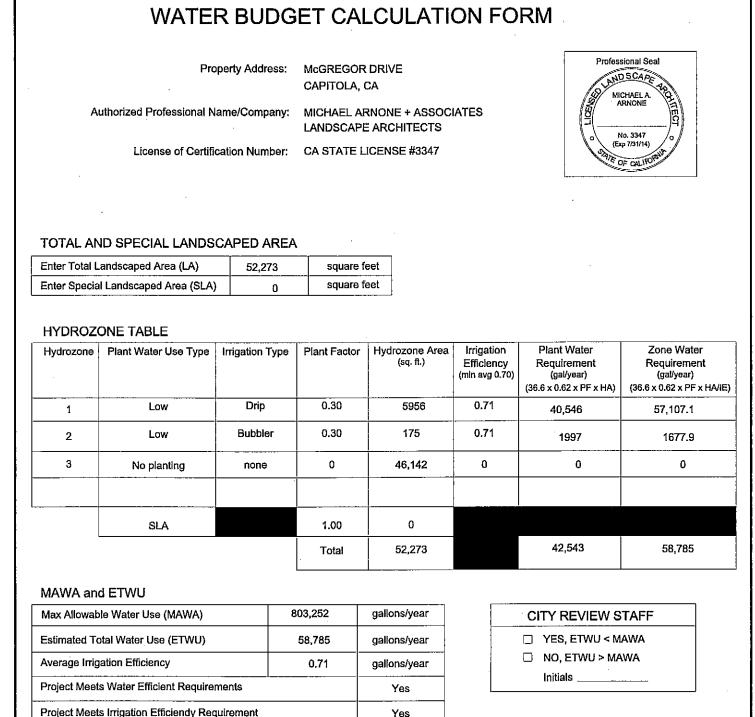
DETAIL	KEY	MANUFACTURER	MODEL#	DESCRIPTION
		Sch. 40 PVC	NSF Approved	1" Irrigation Mainline
		Class 315 PVC	NSF Approved	3/4" Irrigation Lateral
	<del></del>	Sch. 80 PVC	NSF Approved	IRRIGATION SLEEVE UNDER PAVING (TWICE SIZE OF PIPES)
	$\triangleright$	KBI	BALL VALVE- size as needed	PVC BALL VALVE FOR MAINTENANCE SHUTOFF
Α	7	Febco	825 Y BV	1" Reduced Pressure Backflow Device
В	lacktriangle	HUNTER	NODE 100, 200, 400 PGV - 100G	1 station, 2 station and 4 station battery powered remote control valve in valve box with 1" PGV Globe Valve w/ 25 PSI regulator
С		HUNTER	PCZ - 101 - 25	1" PGV valve with 1" HY100 Wye filter and 25 PSI regulator
D	(Qea	RAIN BIRD	44-LRC	1" QUICK COUPLER WITH LOCKING COVER
E	· / ·	RAIN BIRD	3/4" Polyethylene	3/4" drip tubing
E	AS NEEDED	RAIN BIRD	PRESSURE COMPENSATING	1/2 GPH (RED), 1 GPH (BLACK), 2 GPH (GREEN) ISO-FLO EMITTER
F	• •	HUNTER	MSBN-50H	PRESSURE COMPENSATING MULTI STREAM BUBBLER NOZZLE ON PRO-FLEX TUBING w/180 DEGREE PATTERN5 gpm AT 30 PSI
	$^{\diamond}$	RainBird	LOC 16MM 075 MPT ADAPTER	LOCKING 3/4" DRIP END CAP ASSEMBLY

## **IRRIGATION NOTES**

- 1. Contractor shall notify U.S.A. ( Underground Service Alert) at 800 642 2444, prior to start of any excavation or trenching.
- 2. Contractors shall review all plans and documents pertaining to the project prior to the start of work to coordinate work with other trades.
- 3. Contractor shall install irrigation system inaccordance with all local codes and ordinances.
- 4. Drip valves have been designed to operate at a maximum of 4 gallons per minute at 20 p. s. i. static pressure.

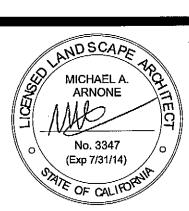
  Irrigation contractor shall verify a static pressure of at least 55 p.s.i. at the point of connection prior to the installation of the irrigation system. Should the p.s.i. or the g.p.m. be insufficient to operate either system, contractor shall notify landscape architect and request review of design.
- 5. Point of connection shall be taken from existing water service on the east side of the property as noted on L-4.1 The contractor shall install backflow device, new mainline and valves as noted on plan. See Irrigation Legend.
- 6. Battery powered control valves shall be used. See Irrigation Legend. Programming of the valves timers shall be the responsibility of the contractor for a period of thirty days after acceptance of work.
- 7. Irrigation design is diagrammatic. Mainline, valves, laterals and other irrigation equipment may be shown outside of planting beds for graphic clarity. All irrigation equipment shall be located in adjacent planting beds. Symbol shown under existing Oak trees is distribution tubing, do not provide emitters for existing Oak trees.
- 8. Irrigation pipe depths: Mainlines under paving shall have 24" cover over pipes. Lateral lines under paving shall have 18" cover over pipes. Sleeves shall be located as per plan. Mainlines in planting beds shall have 12" of cover over pipes. Laterals in planting beds shall have 12" cover over pipes.
- 9. Lateral lines (non pressure lines) sizing guidelines shall be as follows: 3/4" O.D. 0 to 10 GPM; 1" O.D. 11 to 15 GPM; 1 1/4" O.D. 16 to 25 GPM; 1 1/2" O.D. 26 to 30 GPM; 2" O.D. 31 to 55 GPM. Refer to Irrigation Legend and plan sheets for further data.
- 10. Contractor shall determine the number and location of multi outlet emitters based on the plant counts and actual plant locations in the field. Contractor shall adjust all drip distribution tubing to effectively irrigate all plant material.
- 11. Contractor shall provide a minimum of one drip end cap assembly per drip zone for ease of flushing system.

  12. All trees shall be watered using two bubblers as noted in Irrigation Legend. See Detail F/L-5.0



ael Arnone + Associate ANDSCAPE ARCHITECTURE Samuel Place Santa Cruz, CA 95062

MCGREGOR DELTOLATION



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3.31.14 bid set MAA

4.16.14 bid set MAA

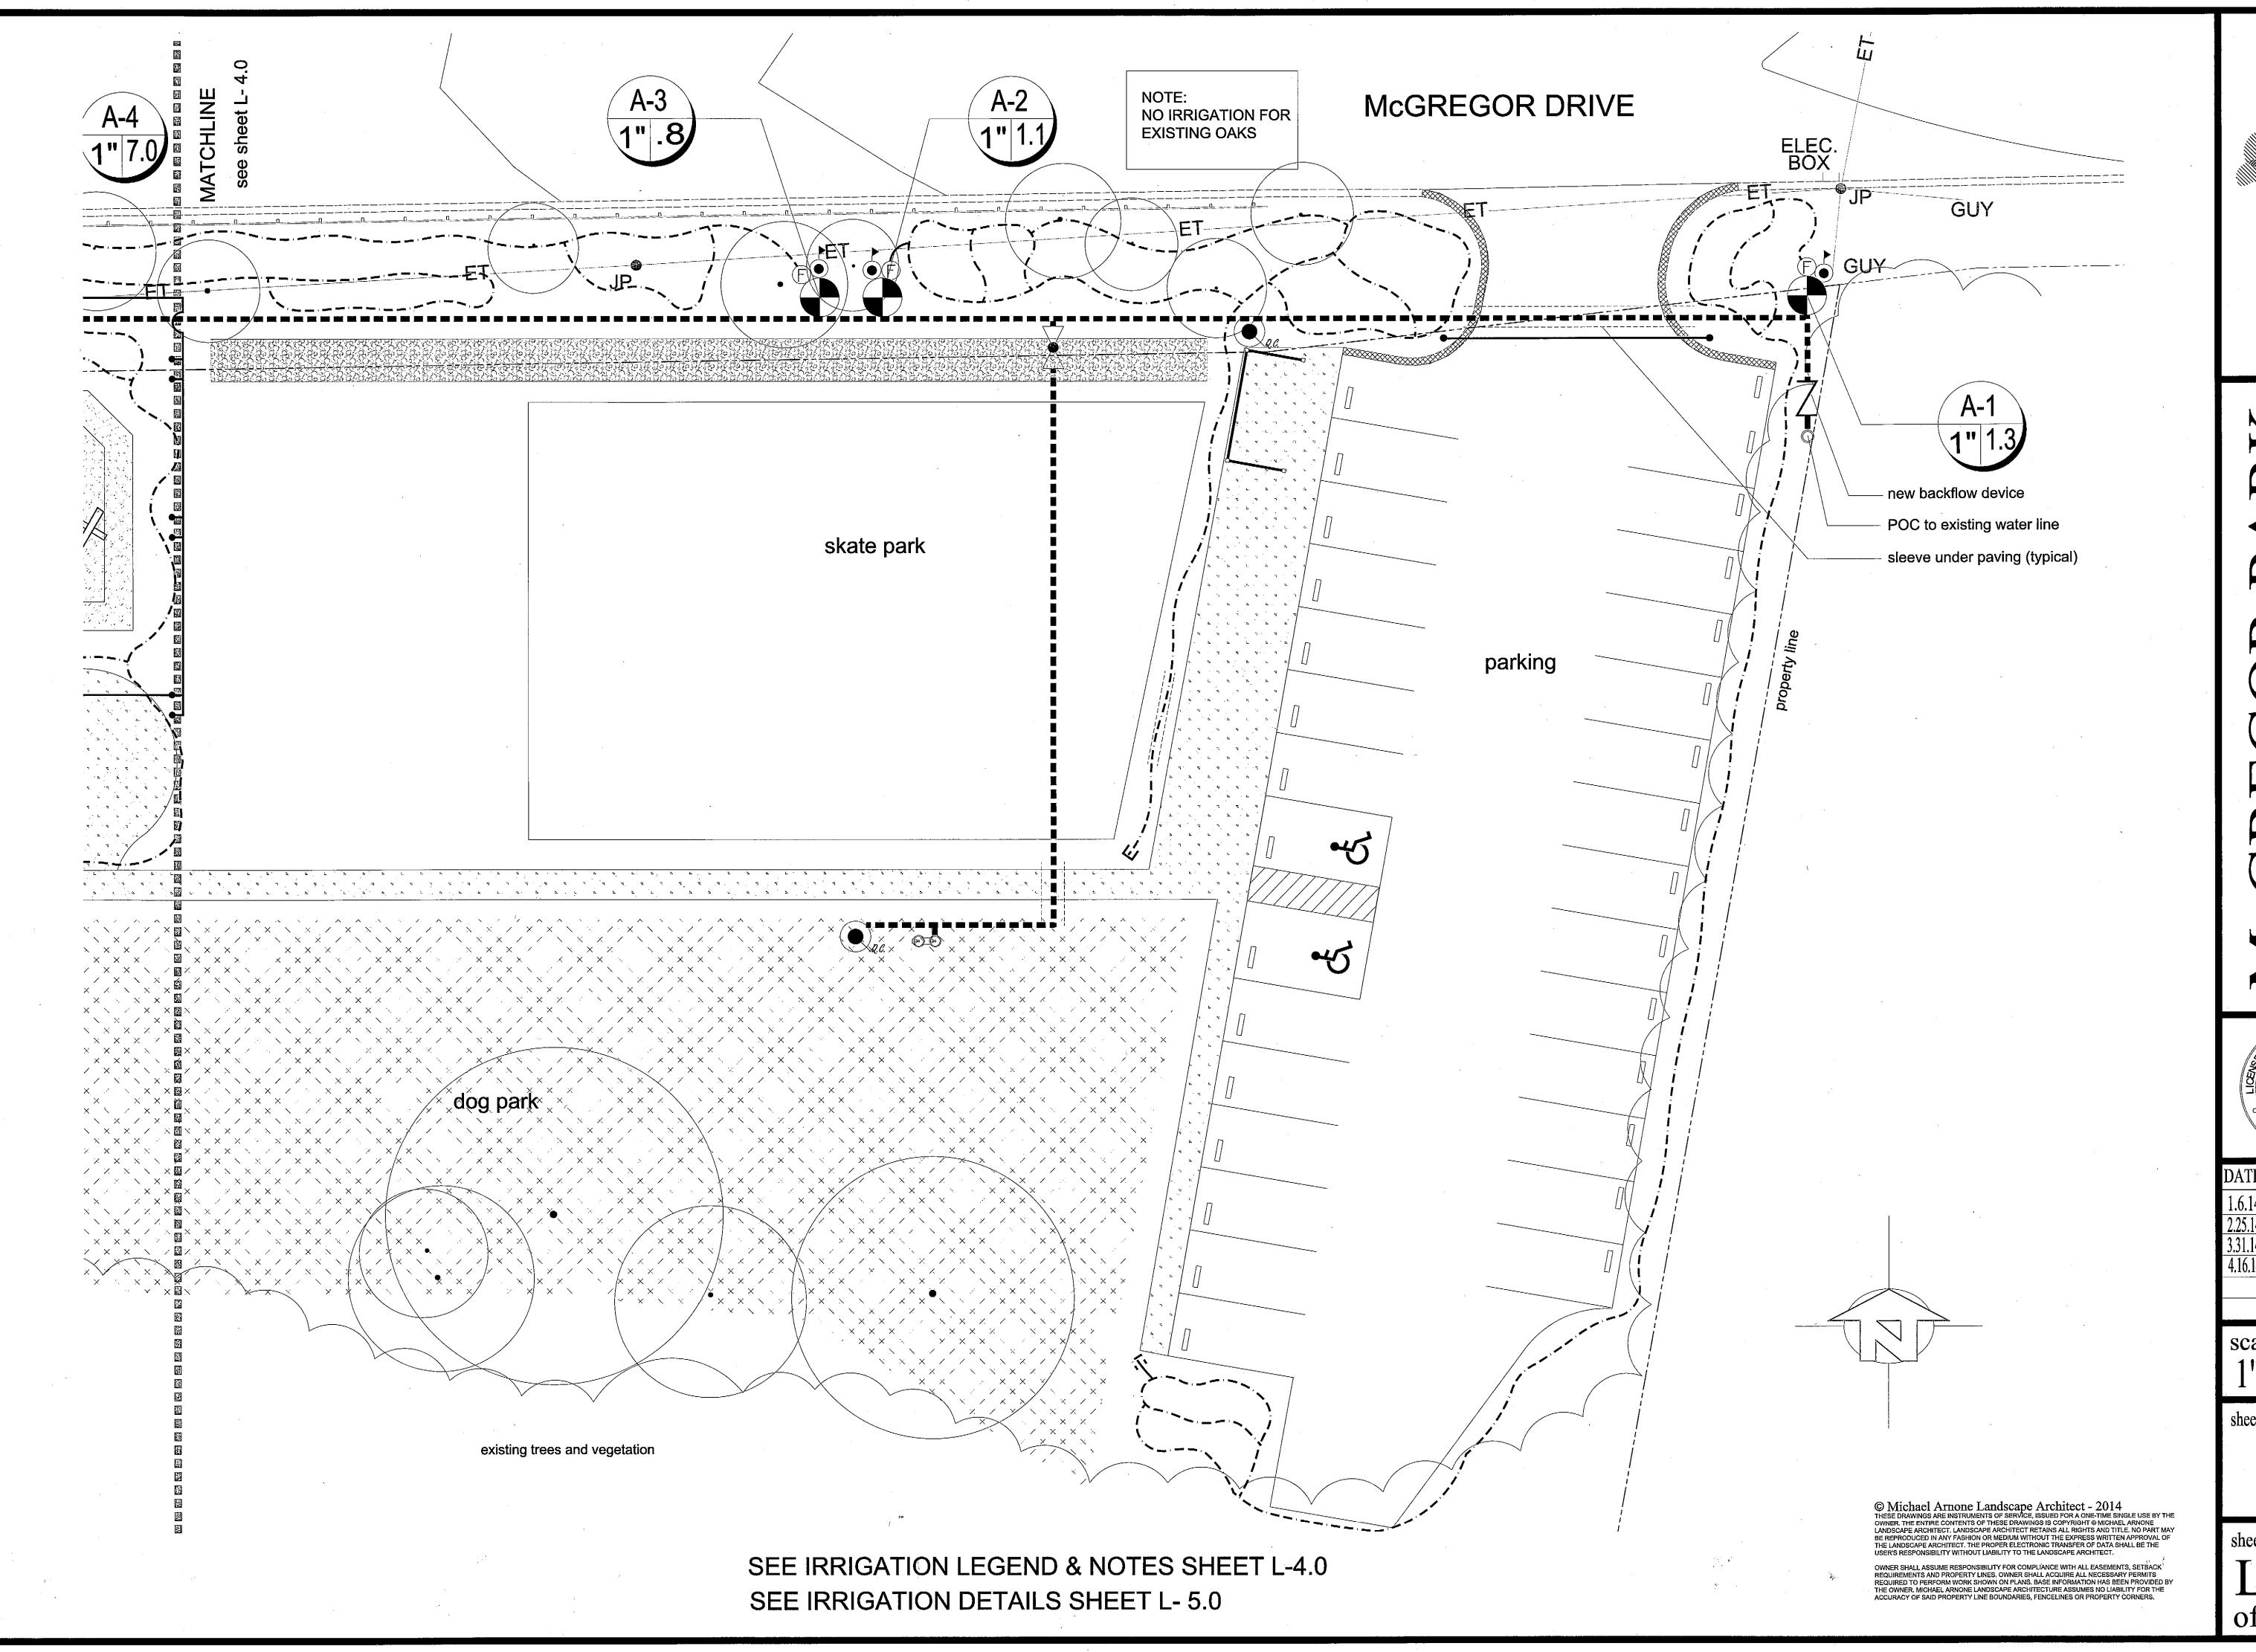
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West Irrigation Plan

sheet number:

L - 4.0 of fourteen



ANDSCAPE ARCHITECTURE
Samuel Place Santa Cruz, CA 95062

MCGREGOR PARK CITY OF CAPITOLA



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1.6.14 planigemisin shift MAA
2.25.14 pod placement MAA
3.31.14 bid set MAA
4.16.14 bid set MAA

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sheet title:

East Irrigation Plan

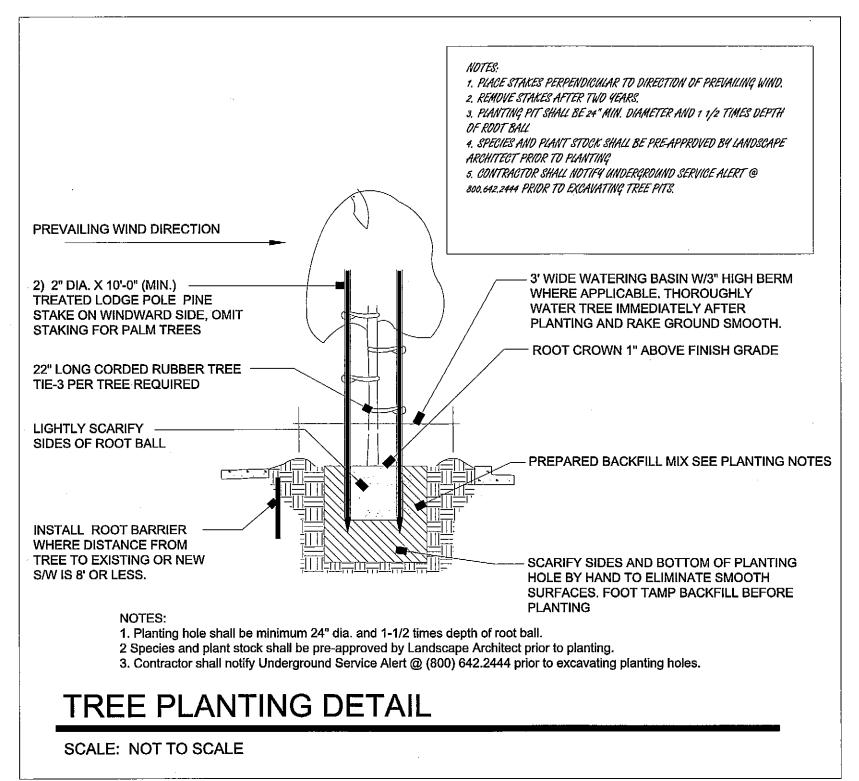
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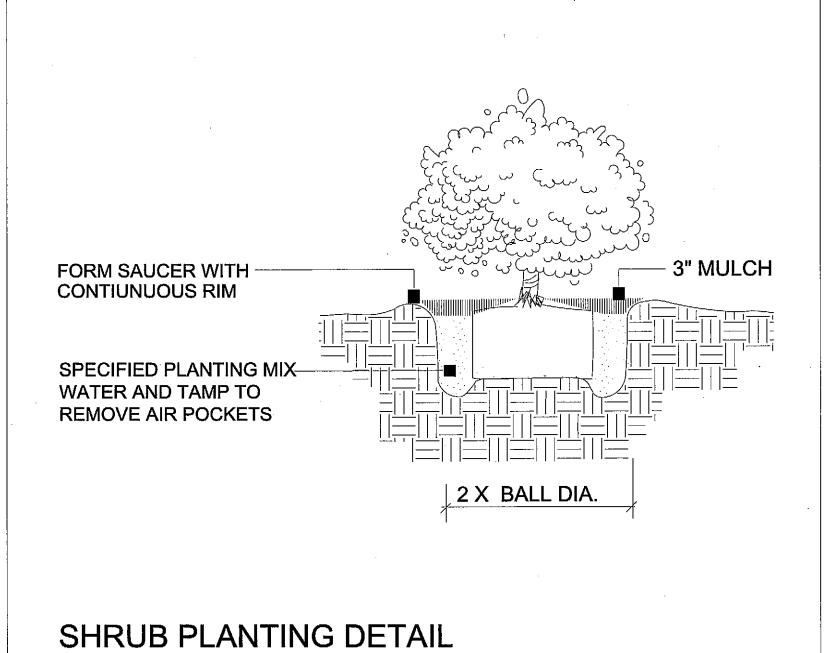
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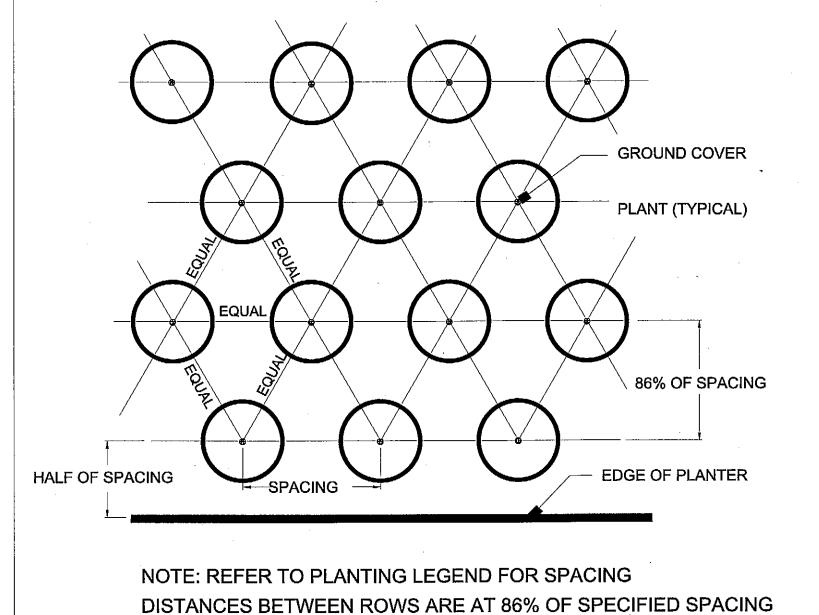
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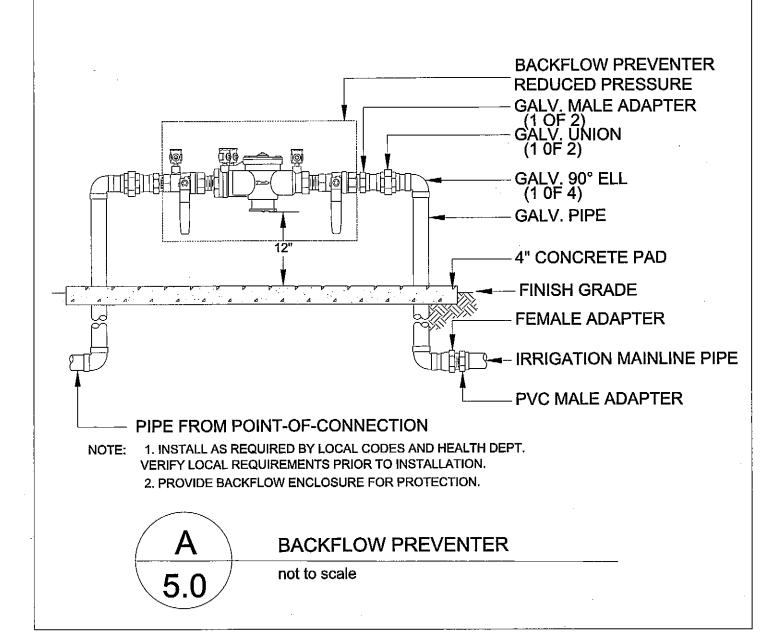


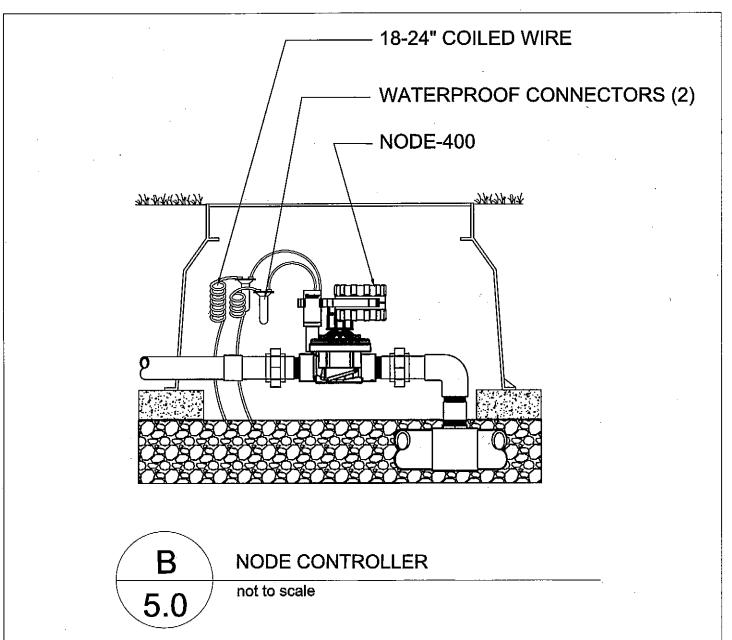
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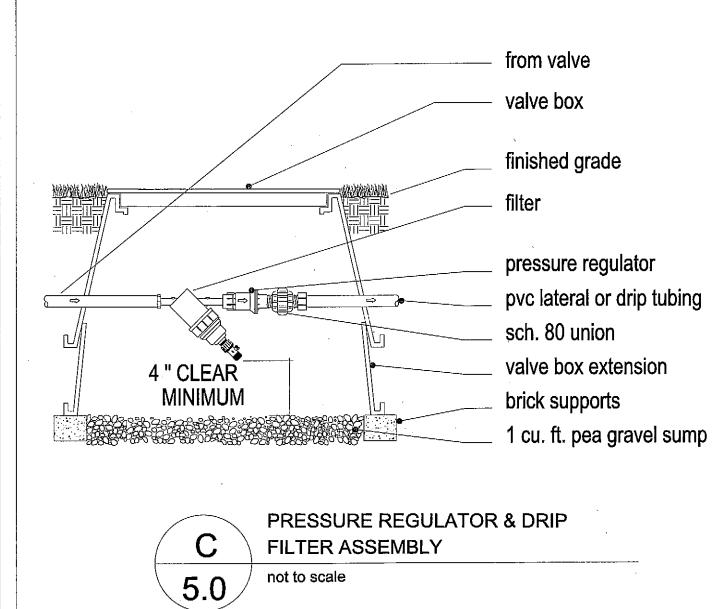


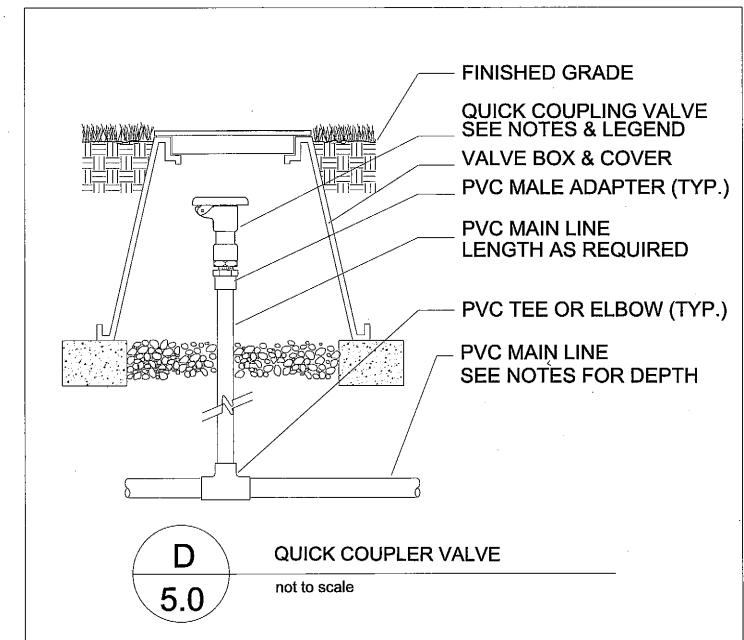
GROUNDCOVER PLANTING DETAIL

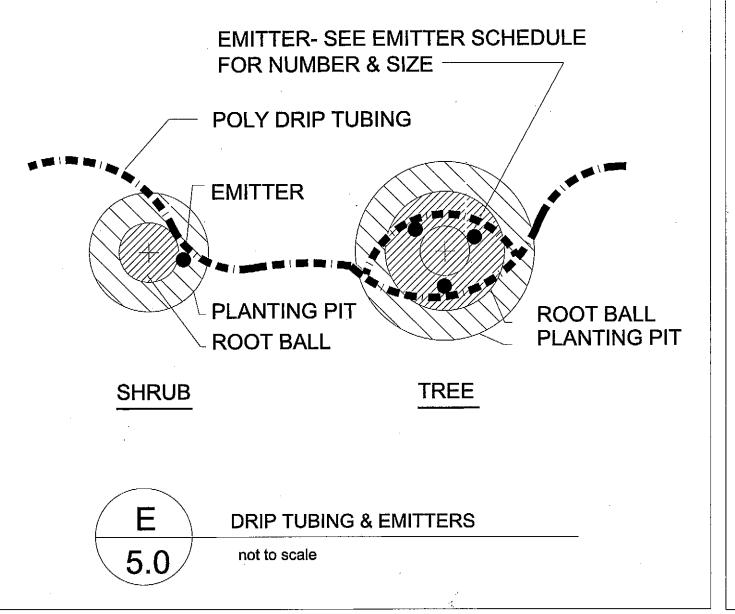
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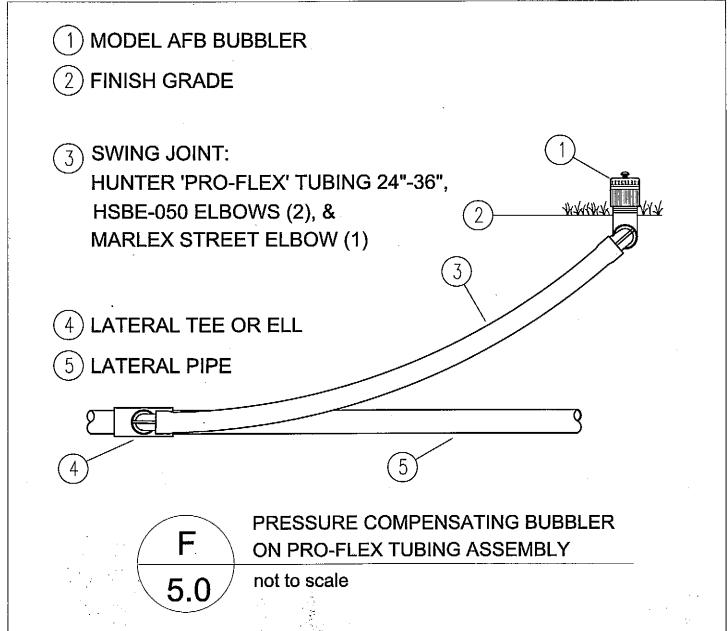








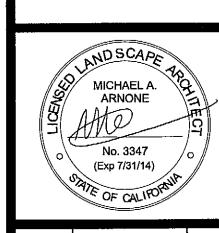






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Planting +
Irrigation
Details

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